27100 164th Avenue

Covington, WA 98042

Miller Hayashi Architects

Southeast

118 North 35th St. Suite 200

ARCHITECT'S STAMP

Seattle, Washington 98103

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Fax: 206 634 0167

CONSULTANT

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Abbreviations

HWD HARDWOOD

IN INCH

INT INTERIOR

LOCK

LAV LAVATORY LIVE LOAD

JT JOINT

HWH HOT WATER HEATER

ID INSIDE DIAMETER

INCL INCLUDE, INCLUDING INSUL INSULATE, INSULATION

LAM LAMINATE, LAMINATED

LIGHT VALENCE LWC LINEAR WOOD CEILING

LINOLEUM LOW

LOW LIGHT

AB ANCHOR BOLT MAS MASONRY ACOUSTICAL MAT'L MATERIAL ADJUSTABLE ADJ MAX MAXIMUM AFF ABOVE FINISH FLOOR MB METAL BASE ALUM ALUMINUM MECH MECHANICAL APC ACOUSTIC PANEL CEILING MEMB MEMBRANE ARCH ARCHITECT, ARCHITECTURAL MFR MANUFACTURER ASF ALUMINUM STOREFRONT MIN MINIMUM MISC MISCELLANEOUS BFF BELOW FINISH FLOOR MTL METAL BLDG BUILDING MW MICROWAVE BLKG BLOCKING BOS BOTTOM OF STRUCTURE N NORTH BTWN BETWEEN NIC NOT IN CONTRACT BUR BUILT-UP ROOF NOM NOMINAL NTS NOT TO SCALE CG CORNER GUARD CH CEILING HEIGHT OC ON CENTER CAST-IN-PLACE CIP OCC OCCUPANTS, OCCUPANCY CONTROL JOINT OD OUTSIDE DIAMETER CENTERLINE OFF OFFICE CLG CEILING OH OVERHAND CLR CLEAR OPNG OPENING COL COLUMN OPP OPPOSITE VIEW CONC CONCRETE OTS OPEN TO STRUCTURE CONST CONSTRUCTION CONT CONTINUOUS PAINT CONTR CONTRACTOR PLUMBING FIXTURE CORR CORRIDOR POLYMER CEMENT CPT CARPET PERF PERFORATED CT CERAMIC TILE PH PANIC HARDWARE CTR CENTER PL PLATE PLAM PLASTIC LAMINATE DEPT DEPARTMENT PLAS PLASTIC PLYWD PLYWOOD DRINKING FOUNTAIN DIAMETER PNL PANEL DIMENSION PNT PAINT, PAINTED DEADLOAD PREFAB PREFABRICATED DOWN PREFIN PREFINISHED DIMENSION POINT PT PRESSURE TREATED DR DOOR PTH PAPER TOWEL HOLDER DOWNSPOUT DW DISHWASHER R RADIUS DWG DRAWING RB RUBBER BASE RCP REFLECTED CEILING PLAN **EXISTING** RD ROOF DRAIN EAST REF REFER, REFERENCE EA EACH REFR REFRIGERATOR EXPANSION BOLT REINF REINFORCE, REINFORCED EB **EXPANSION JOINT** REQD REQUIRED ELEVATION REV REVISION ELEC ELECTRICAL ROOM RO ROUGH OPENING ELEV ELEVATOR EMER EMERGENCY RP RESIN PANEL EQ EQUAL EQUIPMENT SAFF SELF-ADHERED FLEXIBLE FLASHING EW EACH WAY SCHED SCHEDULE EXH EXHAUST SF SQUARE FEET EXP EXPANSION SHT SHEET EXT EXTERIOR SHTG SHEATHING SIM SIMILAR FIXTURE (LIGHT FIXTURE) SMC SUSPENDED METAL CEILING FBO FURNISHED BY OWNER SP SPLASH PAN FLOOR DRAIN SPEC SPECIFICATION, SPECIFIED FIRE EXTINGUISHER SQ SQUARE FEC FIRE EXTINGUISHER CABINET SSF SOLID SURFACING SSTL STAINLESS STEEL FINISH FLOOR STL STEEL FG FINISH GRADE FIN FINISH STOR STORAGE STN STAIN FIXT FIXTURE FLSHG FLASHING STRUCT STRUCTURAL FND FOUNDATION SUSP SUSPENDED FO FACE OF T THERMOSTAT FOIC FURNISHED BY OWNER T&G TONGUE & GROOVE INSTALLED BY CONTRACTOR FOIO FURNISHED AND INSTALLED BY OWNER TEL TELEPHONE FT FOOT, FEET TEMP TEMPORARY TEMP TEMPERED FTG FOOTING FV FIELD VERIFY THK THICK TO TOP OF GA GAUGE TOS TOP OF STRUCTURE GB GRAB BAR TOW TOP OF WALL G&S GLUE & SCREW TYP TYPICAL GALV GALVANIZED UNO UNLESS NOTED OTHERWISE GENERAL CONTRACTOR GEN GENERAL VERIFY GLASS **GRID LINE** VB VAPOR BARRIER GMT GLASS MOSAIC TILE VCT VINYL COMPOSITION TILE GWB GYPSUM BOARD VERT VERTICAL GS GYPSUM SHEATHING VEST VESTIBULE VIF VERIFY IN FIELD HIGH VP VENEER PLASTER HI HIGH HDWR HARDWARE WIDE HM HOLLOW METAL W WATT(S) HORIZ HORIZONTAL WINDOW HR HOUR WITH HT HEIGHT WC WATER CLOSET HVAC HEATING, VENTILATION, AIR CONDITIONING WD WOOD

W/D

WASHER/DRYER

WDF WOOD FLOORING WGP WOOD GRID PANEL W/O WITHOUT


WP WATERPROOF

WWF WELDED WIRE FABRIC

WWM WELDED WIRE MESH

WT WEIGHT

Drawing Symbols

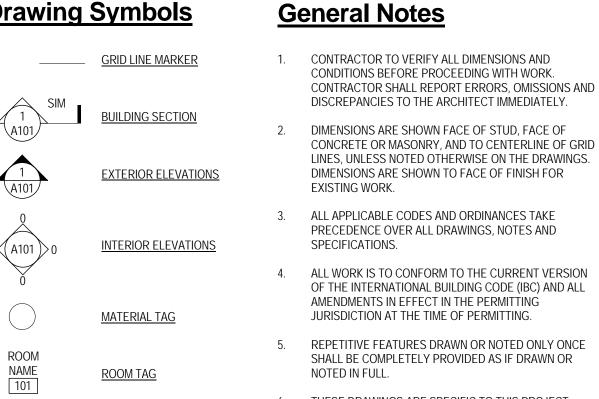

NORTH ARROW 7. STOP WORK AND NOTIFY OWNER IF ASBESTOS OR HAZARDOUS MATERIALS ARE DISCOVERED. 8. DO NOT SCALE THE DRAWINGS. THE CONTRACTOR RE24 -- <u>relite type</u> SHALL REFER TO DIMENSIONS SHOWN ON DRAWINGS AND INFORM ARCHITECT OF ANY DISCREPANCIES.

INTERIOR PARTITION TYPE

NOMINAL FRAMING SIZE

DIMENSION POINT/DATUM

1-HOUR FIRE RATED ENCLOSURE

CEILING HEIGHT

101A <u>→ DOOR NUMBER</u>

CH: 9' - 0"

Materials & Symbols

6. THESE DRAWINGS ARE SPECIFIC TO THIS PROJECT.


BE USED FOR OTHER PROJECTS.

THESE DRAWINGS OR PORTIONS THEREOF SHALL NOT

	COMPACTED EARTH
	SAND, GRAVEL, OR CRUSHED ROCK
4 4	CONCRETE
	METAL
	WOOD - CONTINUOUS
	WOOD - BLOCKING
	WOOD FINISH
	BATT INSULATION
	RIGID INSULATION
	GYPSUM BOARD

MASONRY IN PLAN

Vicinity Map

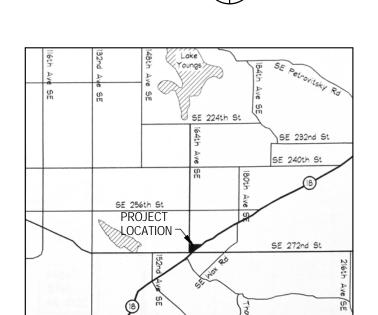

Project Description

PARTIAL RE-ROOFING, RE-CLADDING, AND WINDOW & SKYLIGHT REPLACEMENT OF EXISTING COVINGTON LIBRARY BUILDING.

Legal Description

POR OF SW 1/4 OF SW 1/4 OF SW 1/4 LY S OF N LN OF S 180 FT OF N 1/2 THOF & LY NWLY OF PRIMARY STATE HWY #2 LESS W 20 FT FOR 164TH AVE SE LESS POR CONV TO STATE OF WA BY QCD REC NO 9004091314 LESS POR CONV TO KING CO BY DEED REC NO 9203120453 LESS POR CONDEMNED IN KING CO SUP CT CAUSE NO 83-2-03072-2

Tax Assessor's Parcel Number

252205-9096

Project Address

27100 164TH AVENUE SOUTHWEST COVINGTON, WA 98042

<u>Owner</u>


KING COUNTY LIBRARY SYSTEM 960 NEWPORT WAY NW ISSAQUAH, WA 98027

Architect

MILLER HAYASHI ARCHITECTS 118 N 35TH STREET, SUITE 200 SEATTLE, WA 98103 206-634-0177 CONTACT: BRUCE HAYASHI, ERIK SALISBURY

Mechanical/ Electrical

HARGIS ENGINEERS 600 STEWART ST., SUITE 1000 SEATTLE, WA 98101

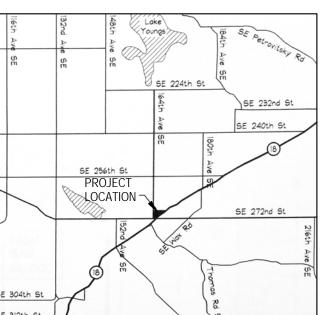

Sheet Index

Architectural

Architectural

AA1.00 Title Sheet, Sheet Index, General Notes Architectural Architectural A1.00 Site Plan Architectural A2.01 Roof Plan **Exterior Roof Elevations** Architectural A3.00 A3.01 **Exterior Roof Elevations** Architectural A4.00 Architectural Wall Sections Architectural A6.00 **Exterior Roof Details**

E1.01 Electrical Roof Plan Electrical Legend, Abbreviations, General Notes and Sheet Index Mechanical Mechanical M1.01 Mechanical Roof Plan Mechanical M2.01 Mechanical Details

A6.10 Window & Skylight Details

Exterior Roof Details

A6.01

PHASE

Bid Set

5/10/16

REVISIONS

Date

Description

SHEET TITLE

Title Sheet, Sheet Index, General **Notes**

SHEET NO.

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Building Code Analysis

- APPROXIMATE AREA OF CONTRACTOR LAY DOWN AREA. COORDINATE EXACT LOCATION AND REQURIEMENTS W/

CONSTRUCTION TYPE: VB - SPRINKLERED (NO CHANGE)
BUILDING AREA: 22,867 S.F. (NO CHANGE)

Elev. 377'-6"

5/10/16

Bid Set

REVISIONS

Land Use Code Analysis

DOWNTOWN COMMERCIAL PUBLIC LIBRARY 31'-8" (NO CHANGE) ZONING: USE: EXISTING HEIGHT:

Washington State Energy Code **Requirements**

ENVELOPE REQUIREMENTS (per Table C402.2 & C402.3) ROOF INSULATION ABOVE DECK REQUIRED: PROVIDED: R-30ci R-30ci WINDOWS, FIXED METAL FRAMING U-VALUE: SHGC:

0.38 MAX 0.40 MAX SKYLIGHTS 0.50 MAX 0.35 MAX


SHEET TITLE Site Plan

SHEET NO.

MILLER HAYASHI ARCHITECTS 1603



164TH AVENUE SOUTHE

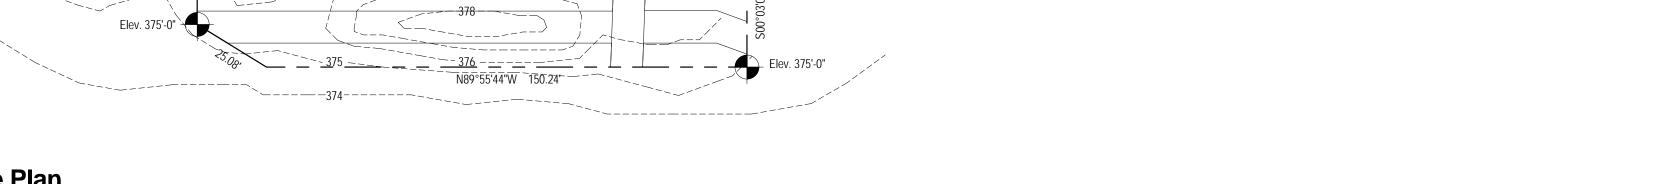

(E) FIRE LANE

(E) ASPHALT PARKING LOT

AREA OF WORK = 10,236 SF

ROOF ELEV. 394.37 —

ROOF ELEV. 408.50 —

__(E) ASPHALT PARKING LOT—

-├ (E) ASPHALT ├ PARKING LOT -

— (É) ASPHALT PARKING LOT ⁻

(E) ASPHALT__ --PARKING LOT


(E) CONC WALK —

172' - 6"


S89°51'23"E 625.93'


EXISTING LIBRARY: 27100 164TH AVENUE SOUTHEAST COVINGTON, WA 98042

(E) ASPHALT SERVICE AREA

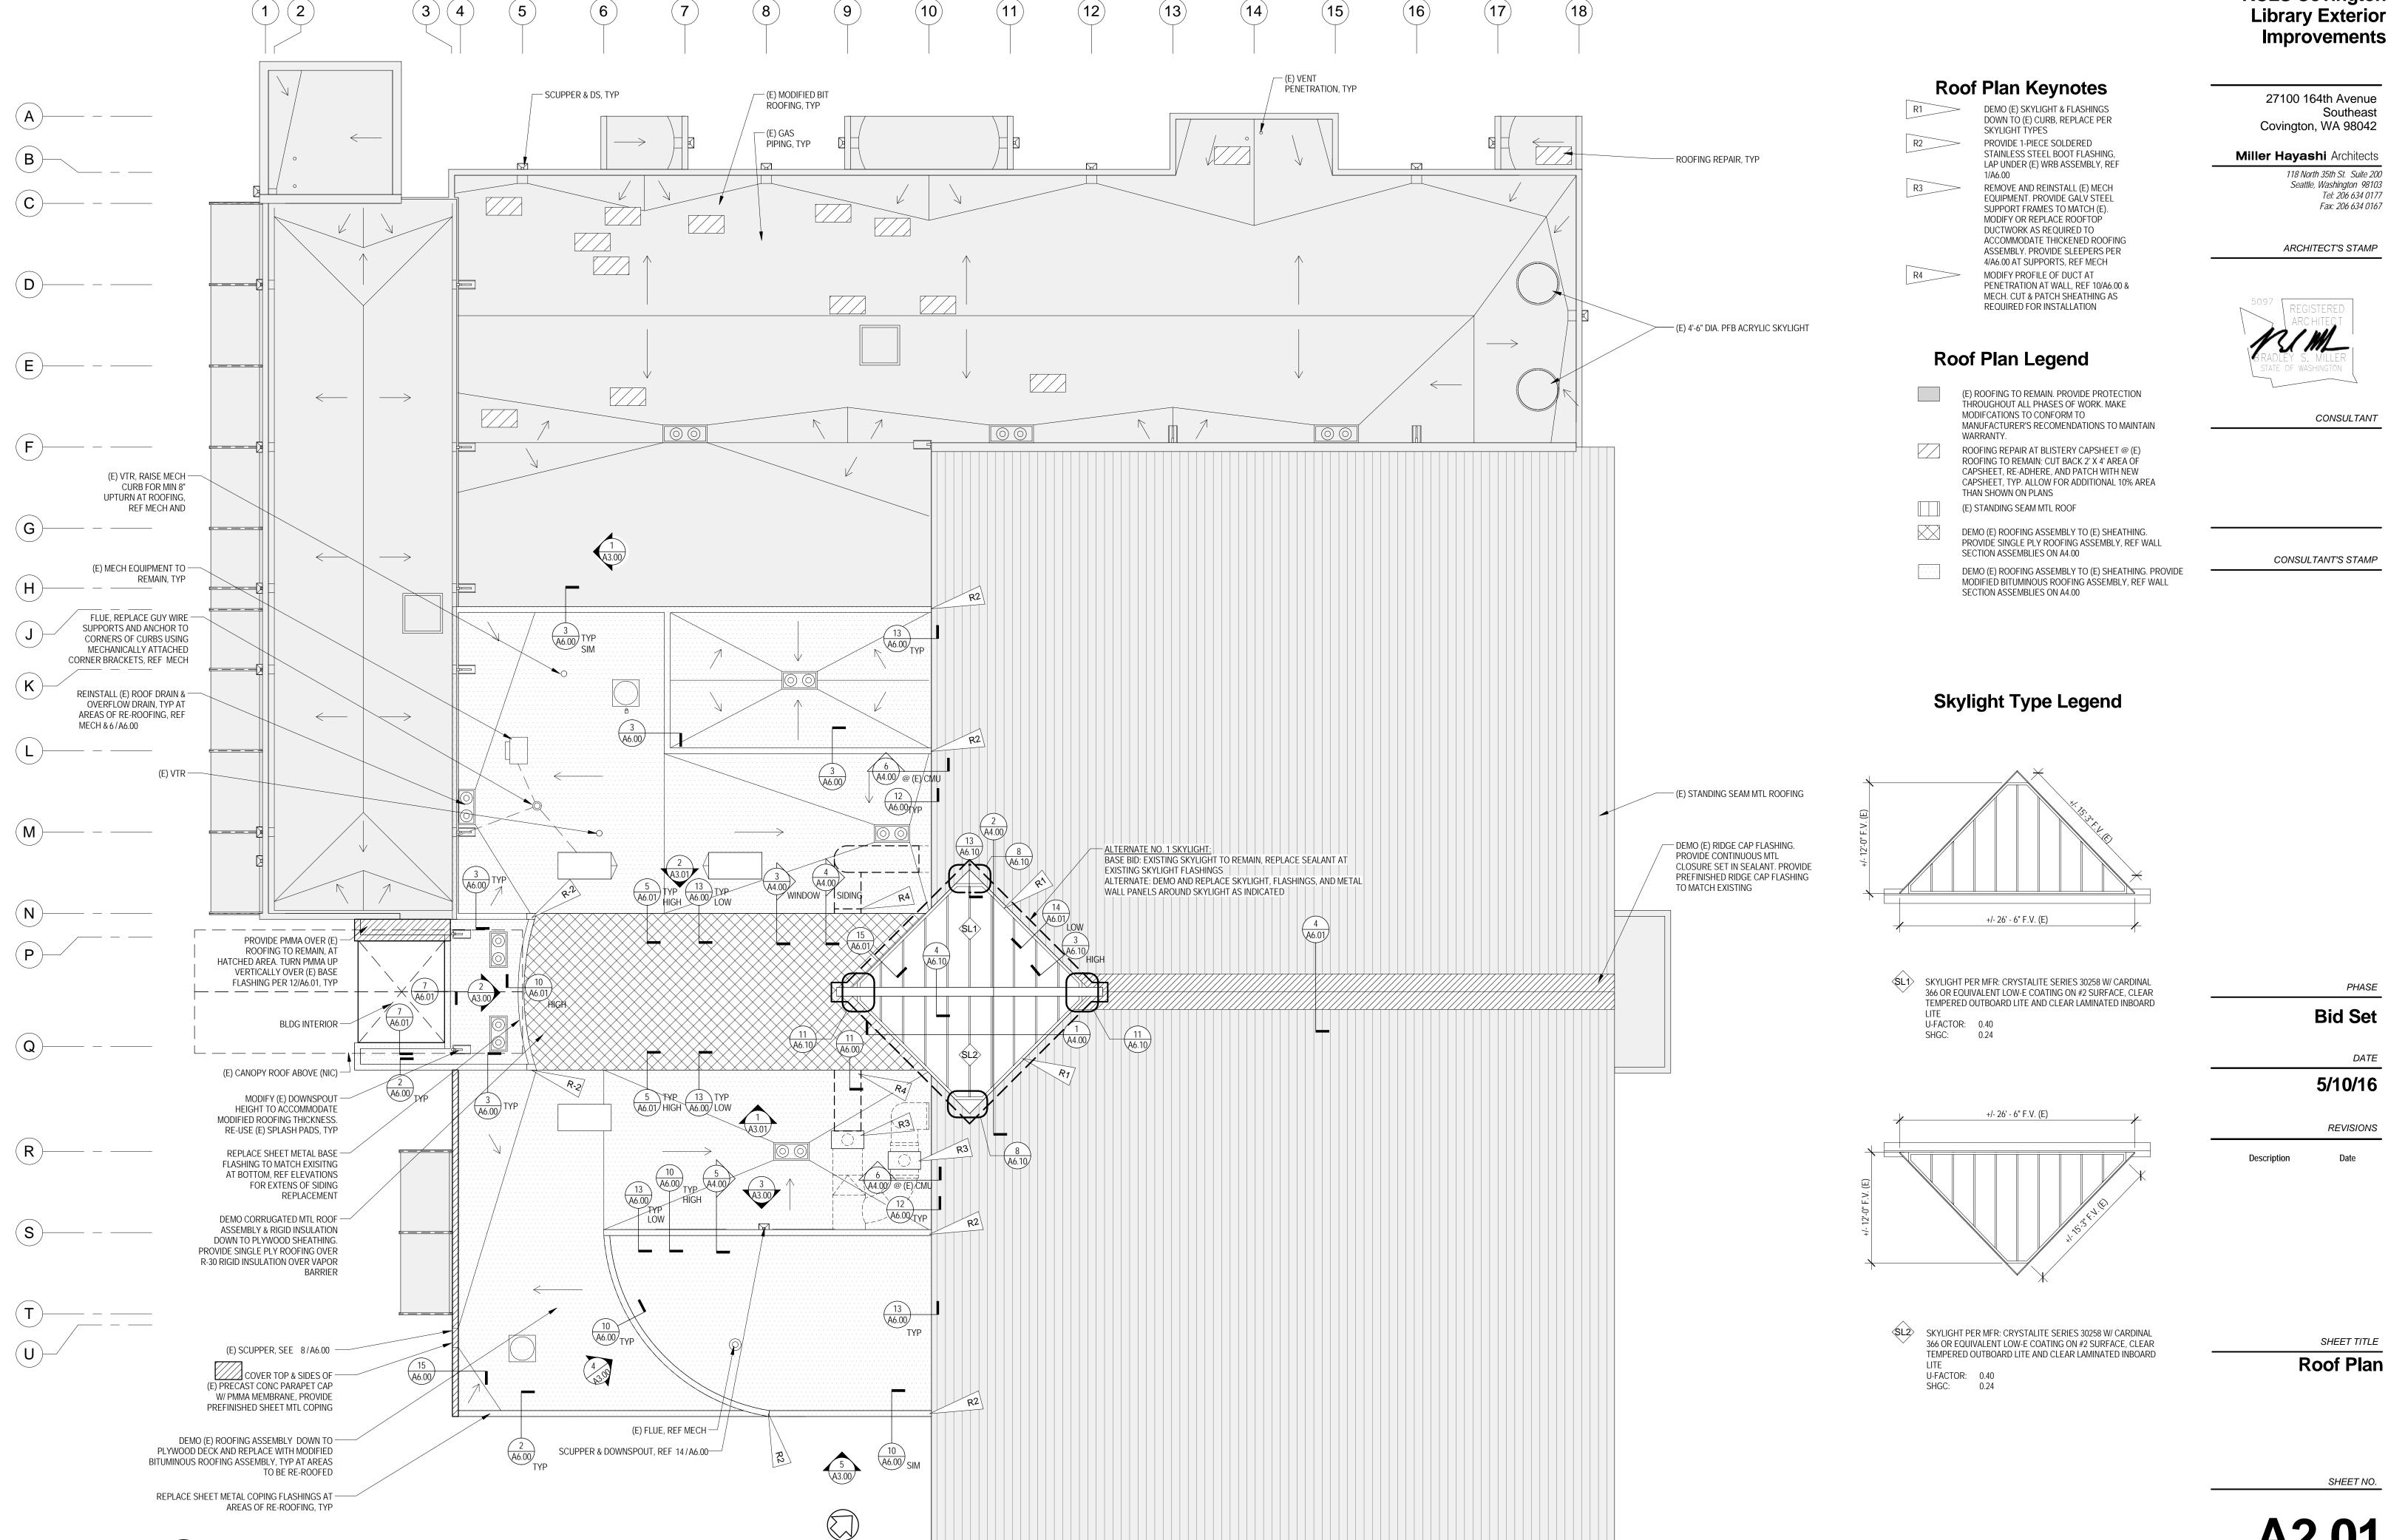

Roof Plan

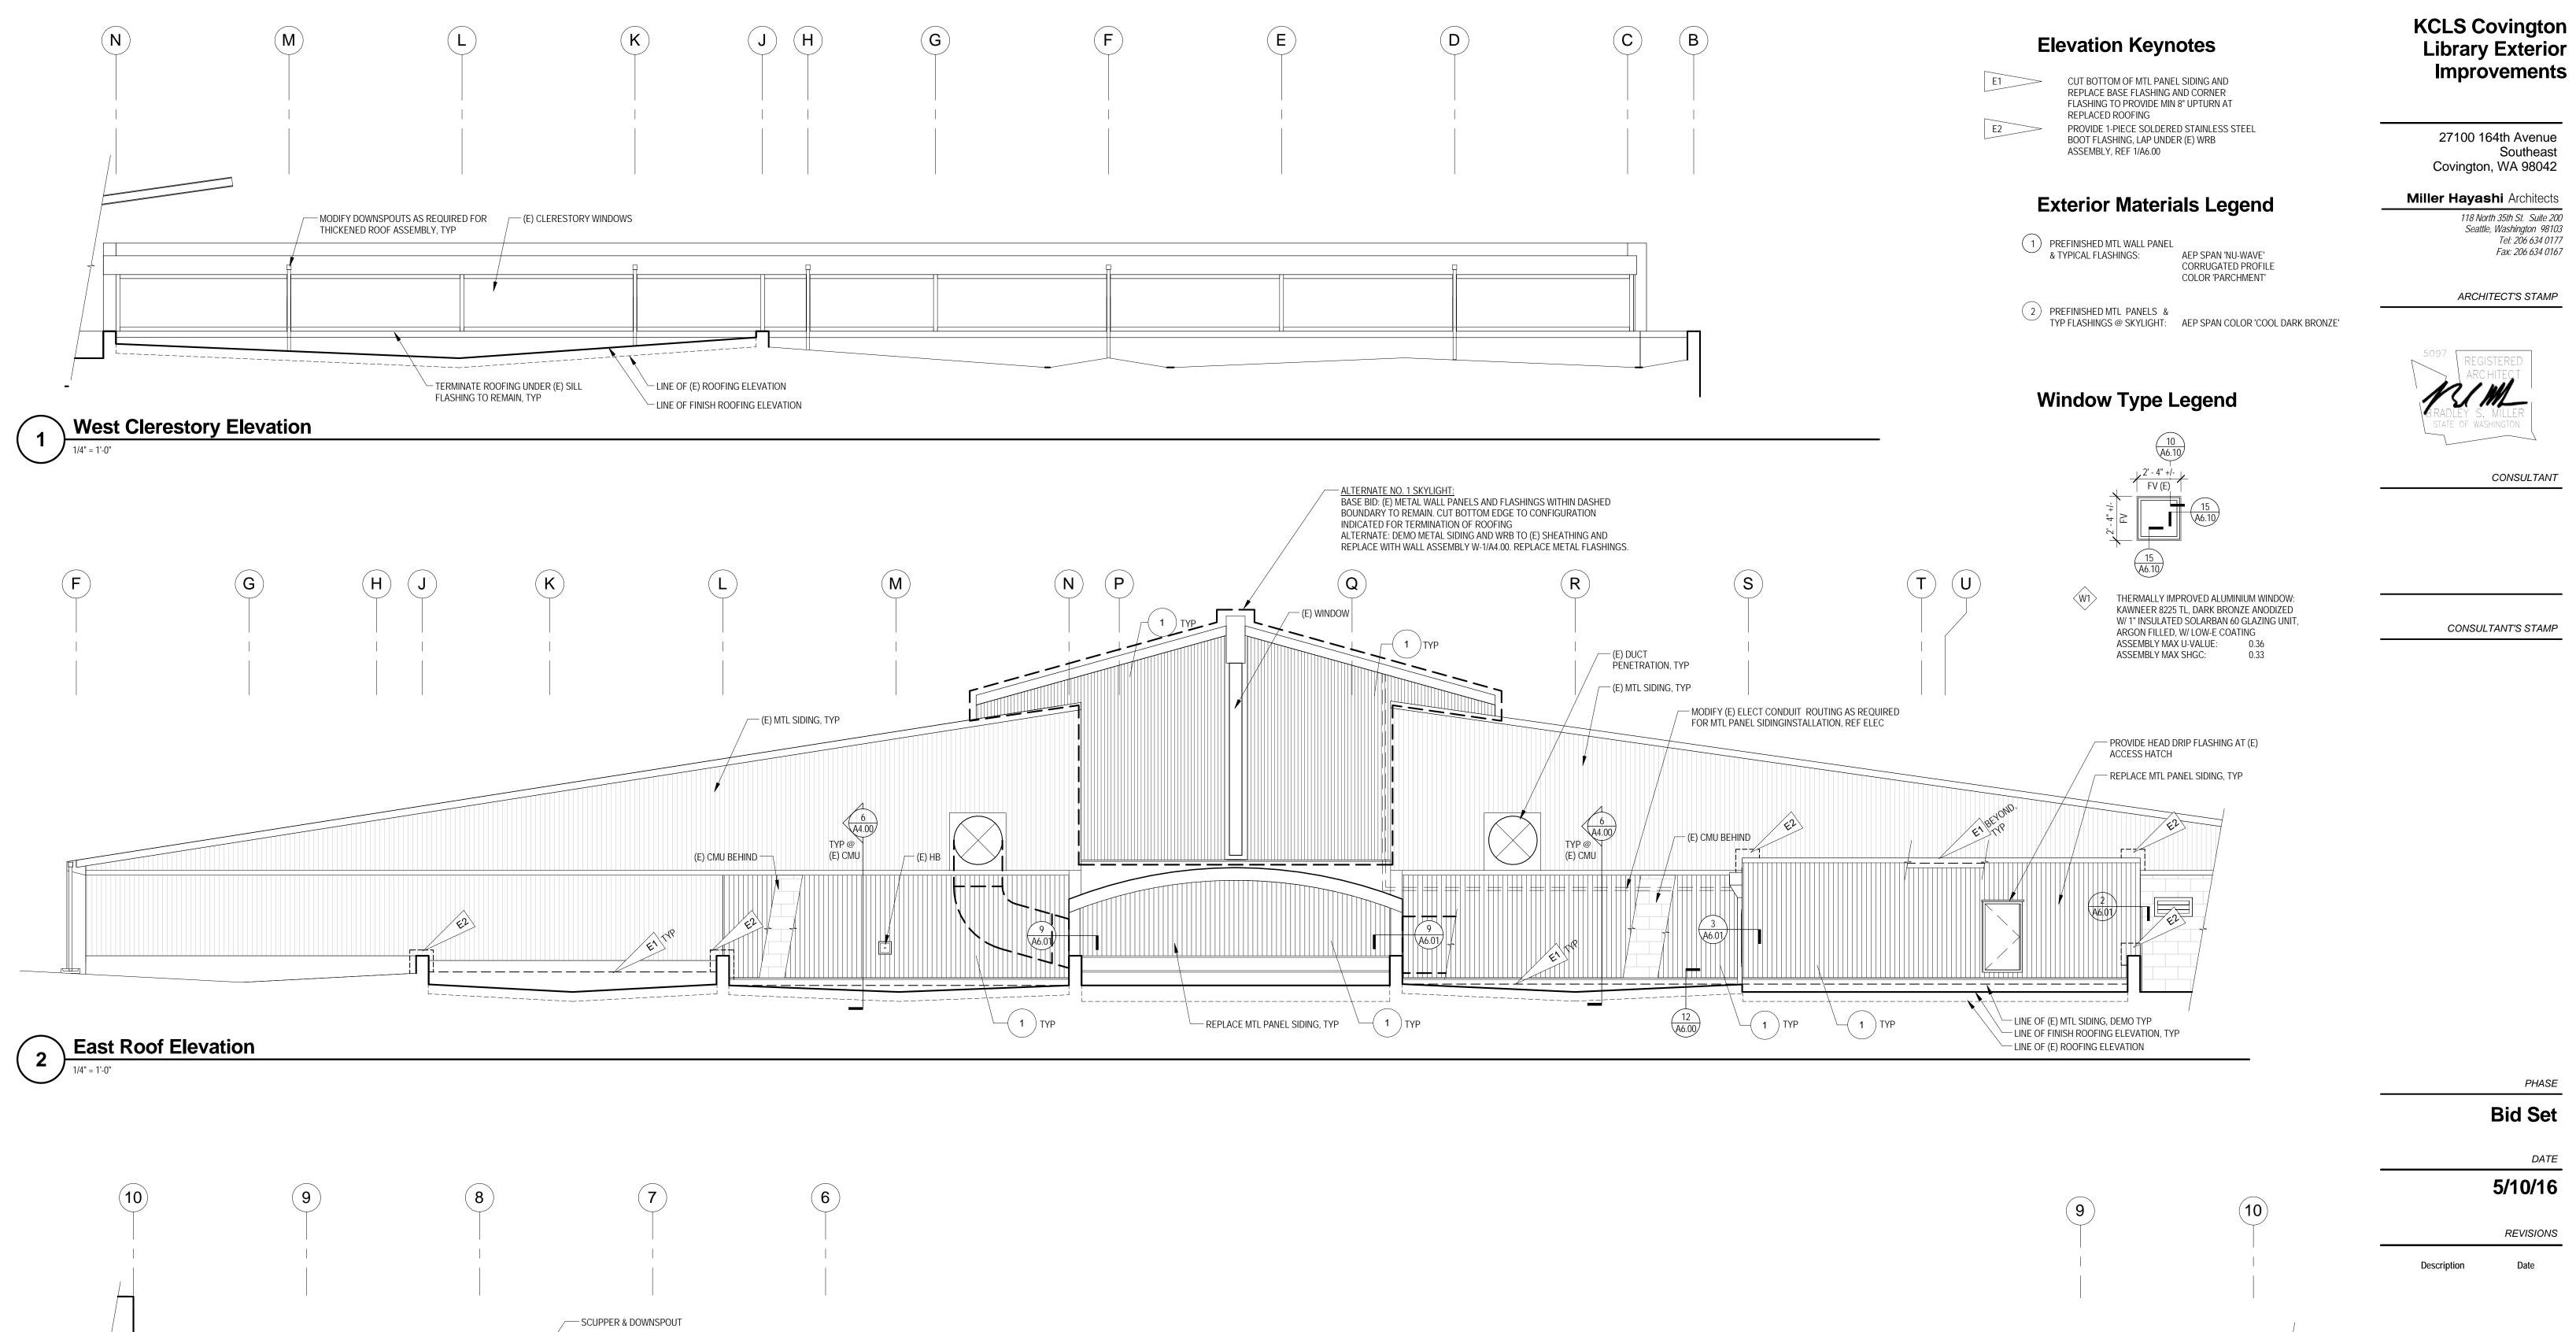

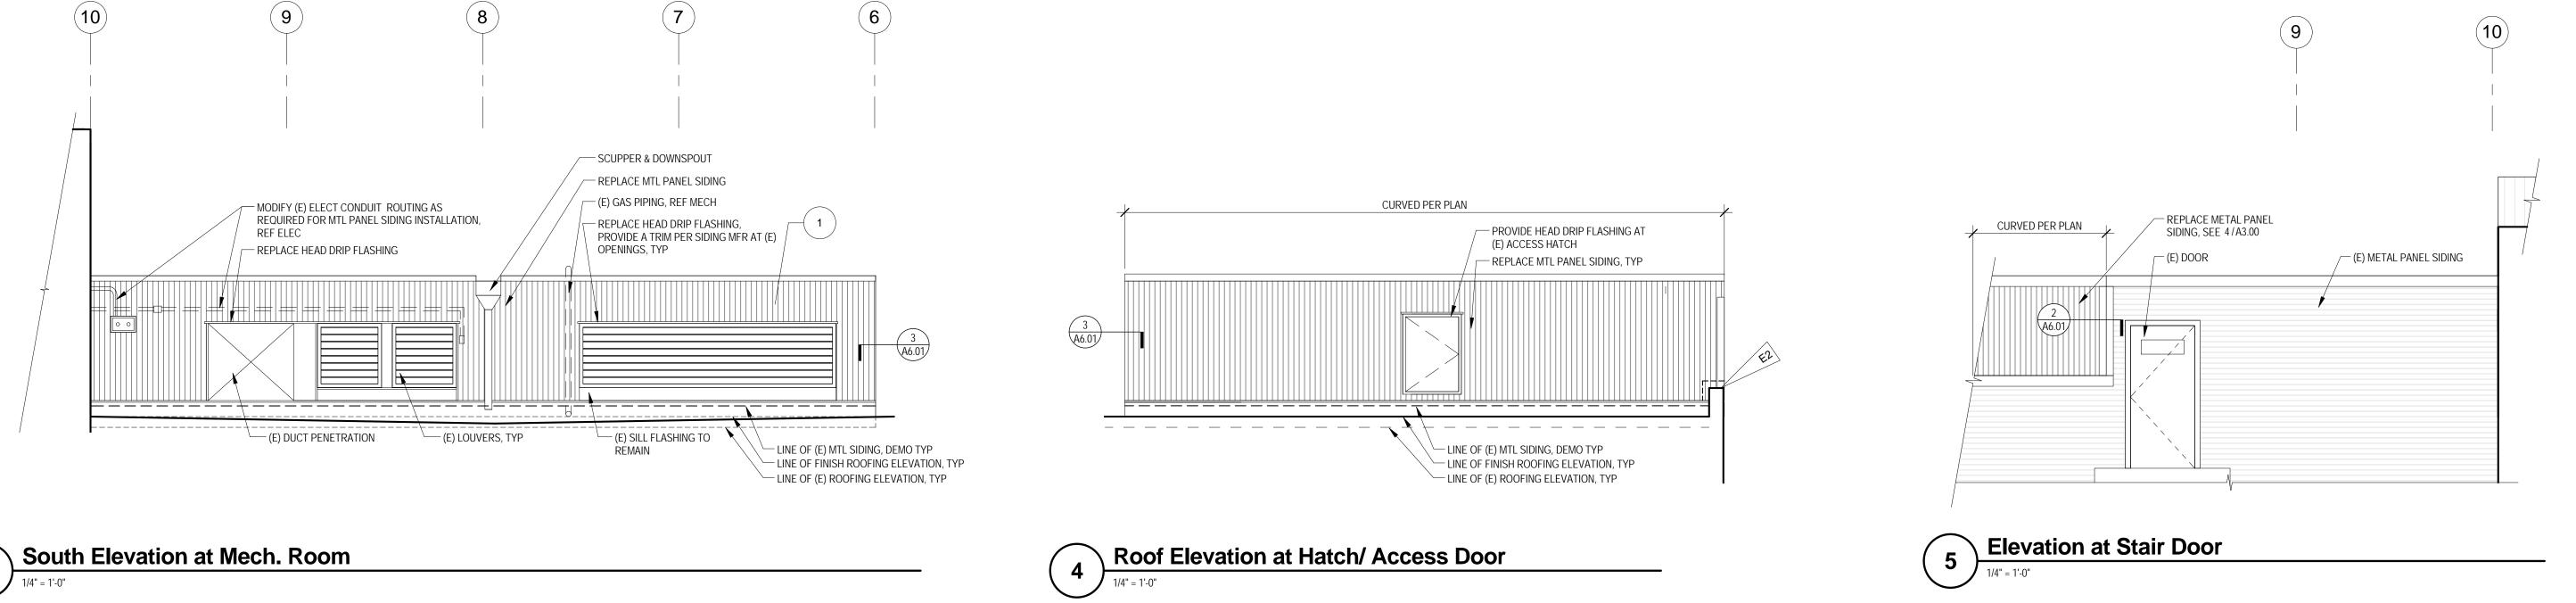


A3.00


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SHEET TITLE

Exterior Roof

Elevations



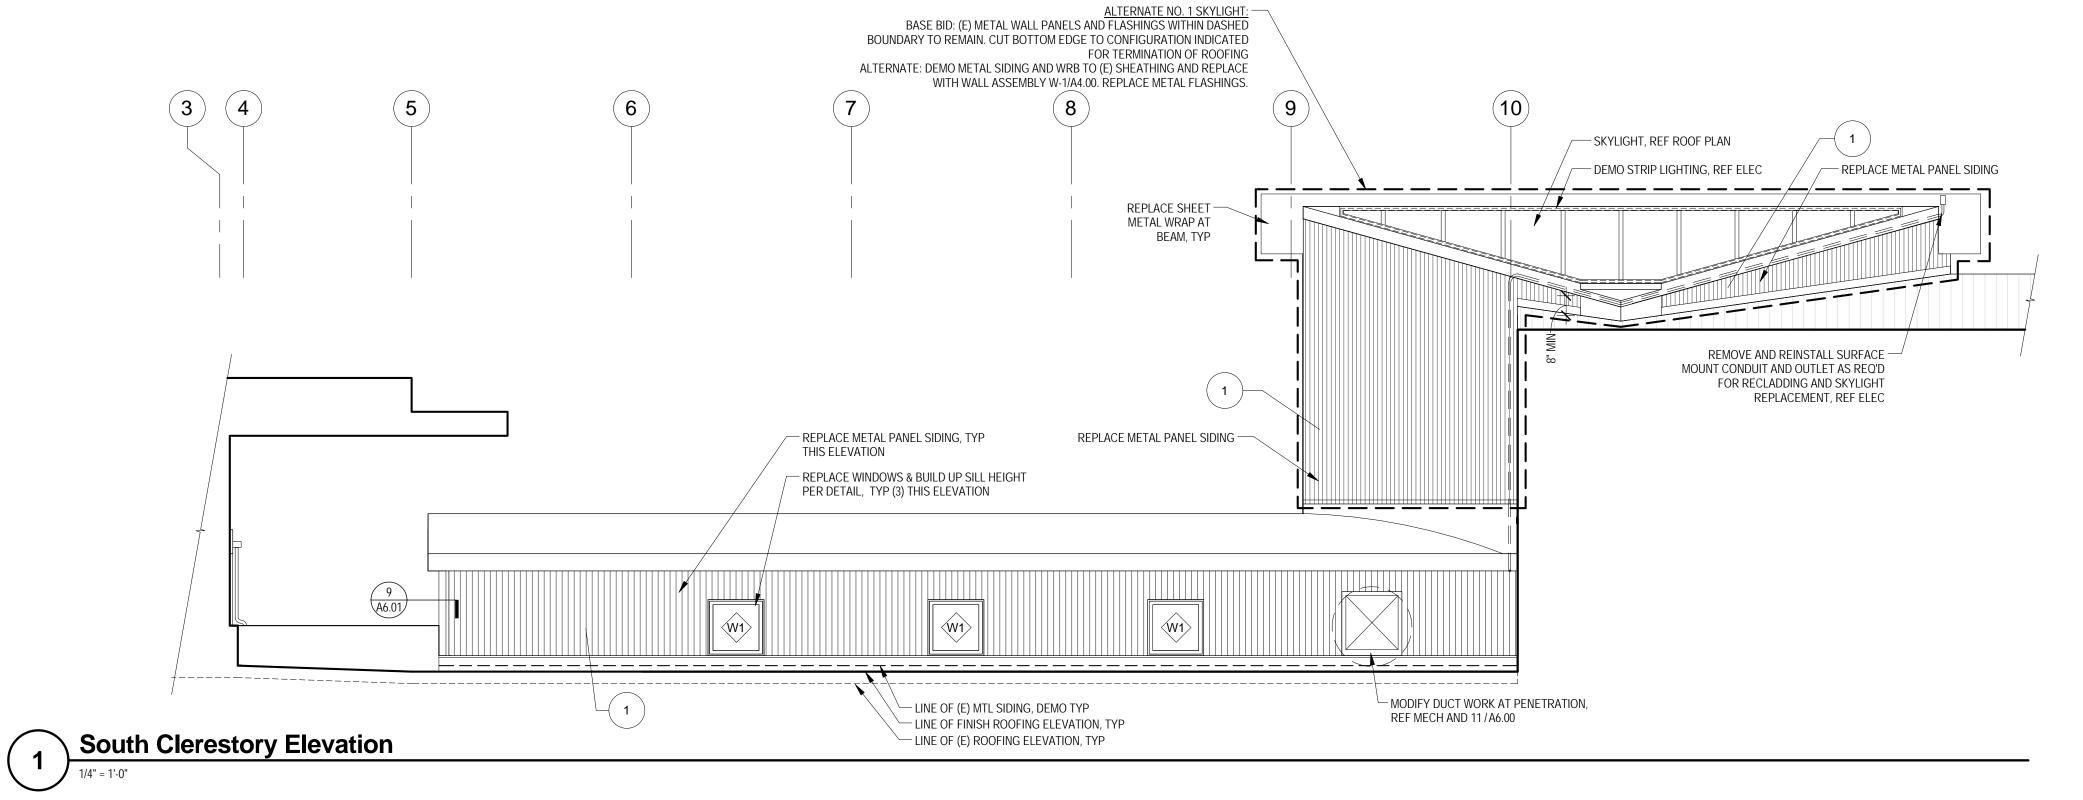

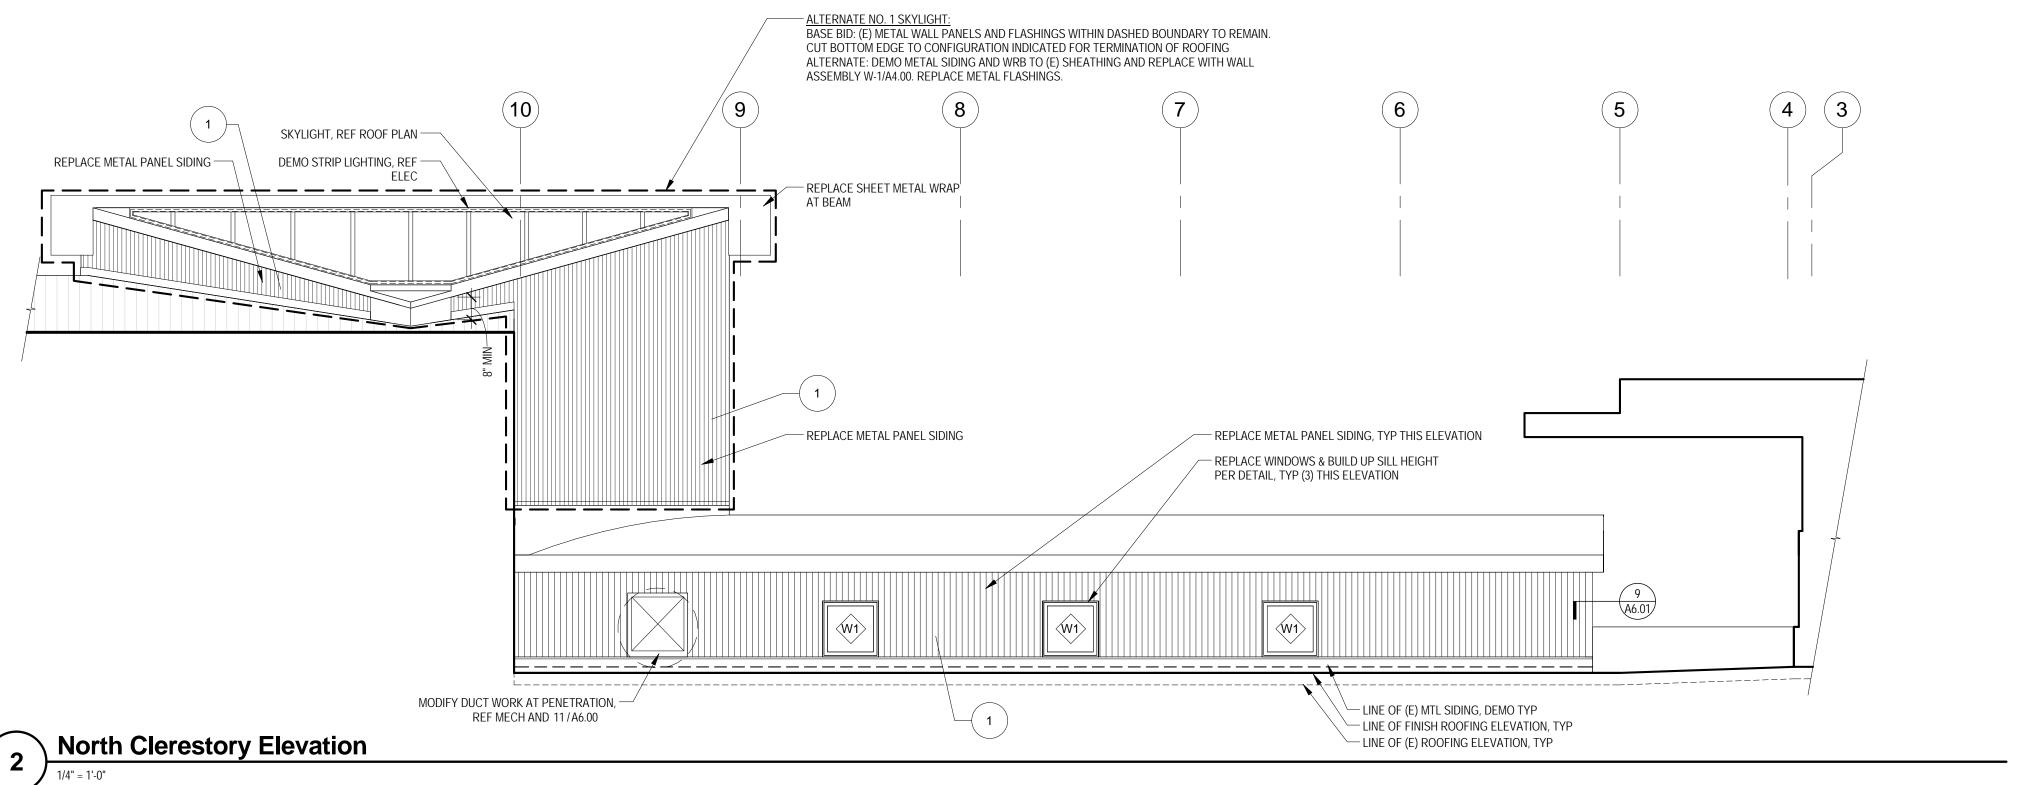Elevation Keynotes

CUT BOTTOM OF MTL PANEL SIDING AND REPLACE BASE FLASHING AND CORNER FLASHING TO PROVIDE MIN 8" UPTURN AT REPLACED ROOFING

FLASHING TO PROVIDE MIN 8" UPTURN AT REPLACED ROOFING

PROVIDE 1-PIECE SOLDERED STAINLESS STEEL BOOT FLASHING, LAP UNDER (E) WRB ASSEMBLY, REF 1/A6.00


Exterior Materials Legend

1 PREFINISHED MTL WALL PANEL & TYPICAL FLASHINGS:

AEP SPAN 'NU-WAVE'
CORRUGATED PROFILE
COLOR 'PARCHMENT'

PREFINISHED MTL PANELS & TYP FLASHINGS @ SKYLIGHT: AEP SPAN COLOR 'COOL DARK BRONZE'

Window Type Legend

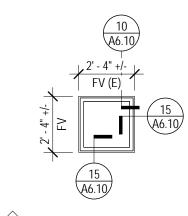

THERMALLY IMPROVED ALUMINIUM WINDOW:
KAWNEER 8225 TL, DARK BRONZE ANODIZED
W/ 1" INSULATED SOLARBAN 60 GLAZING UNIT,
ARGON FILLED, W/ LOW-E COATING
ASSEMBLY MAX U-VALUE: 0.36
ASSEMBLY MAX SHGC: 0.33

KCLS Covington
Library Exterior
Improvements

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PHASE

Bid Set

5/10/16

REVISIONS


Description Date

SHEET TITLE


Exterior Roof Elevations

SHEET NO.

A3.01
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A4.00
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Typical Base Flashing at Modified Bit

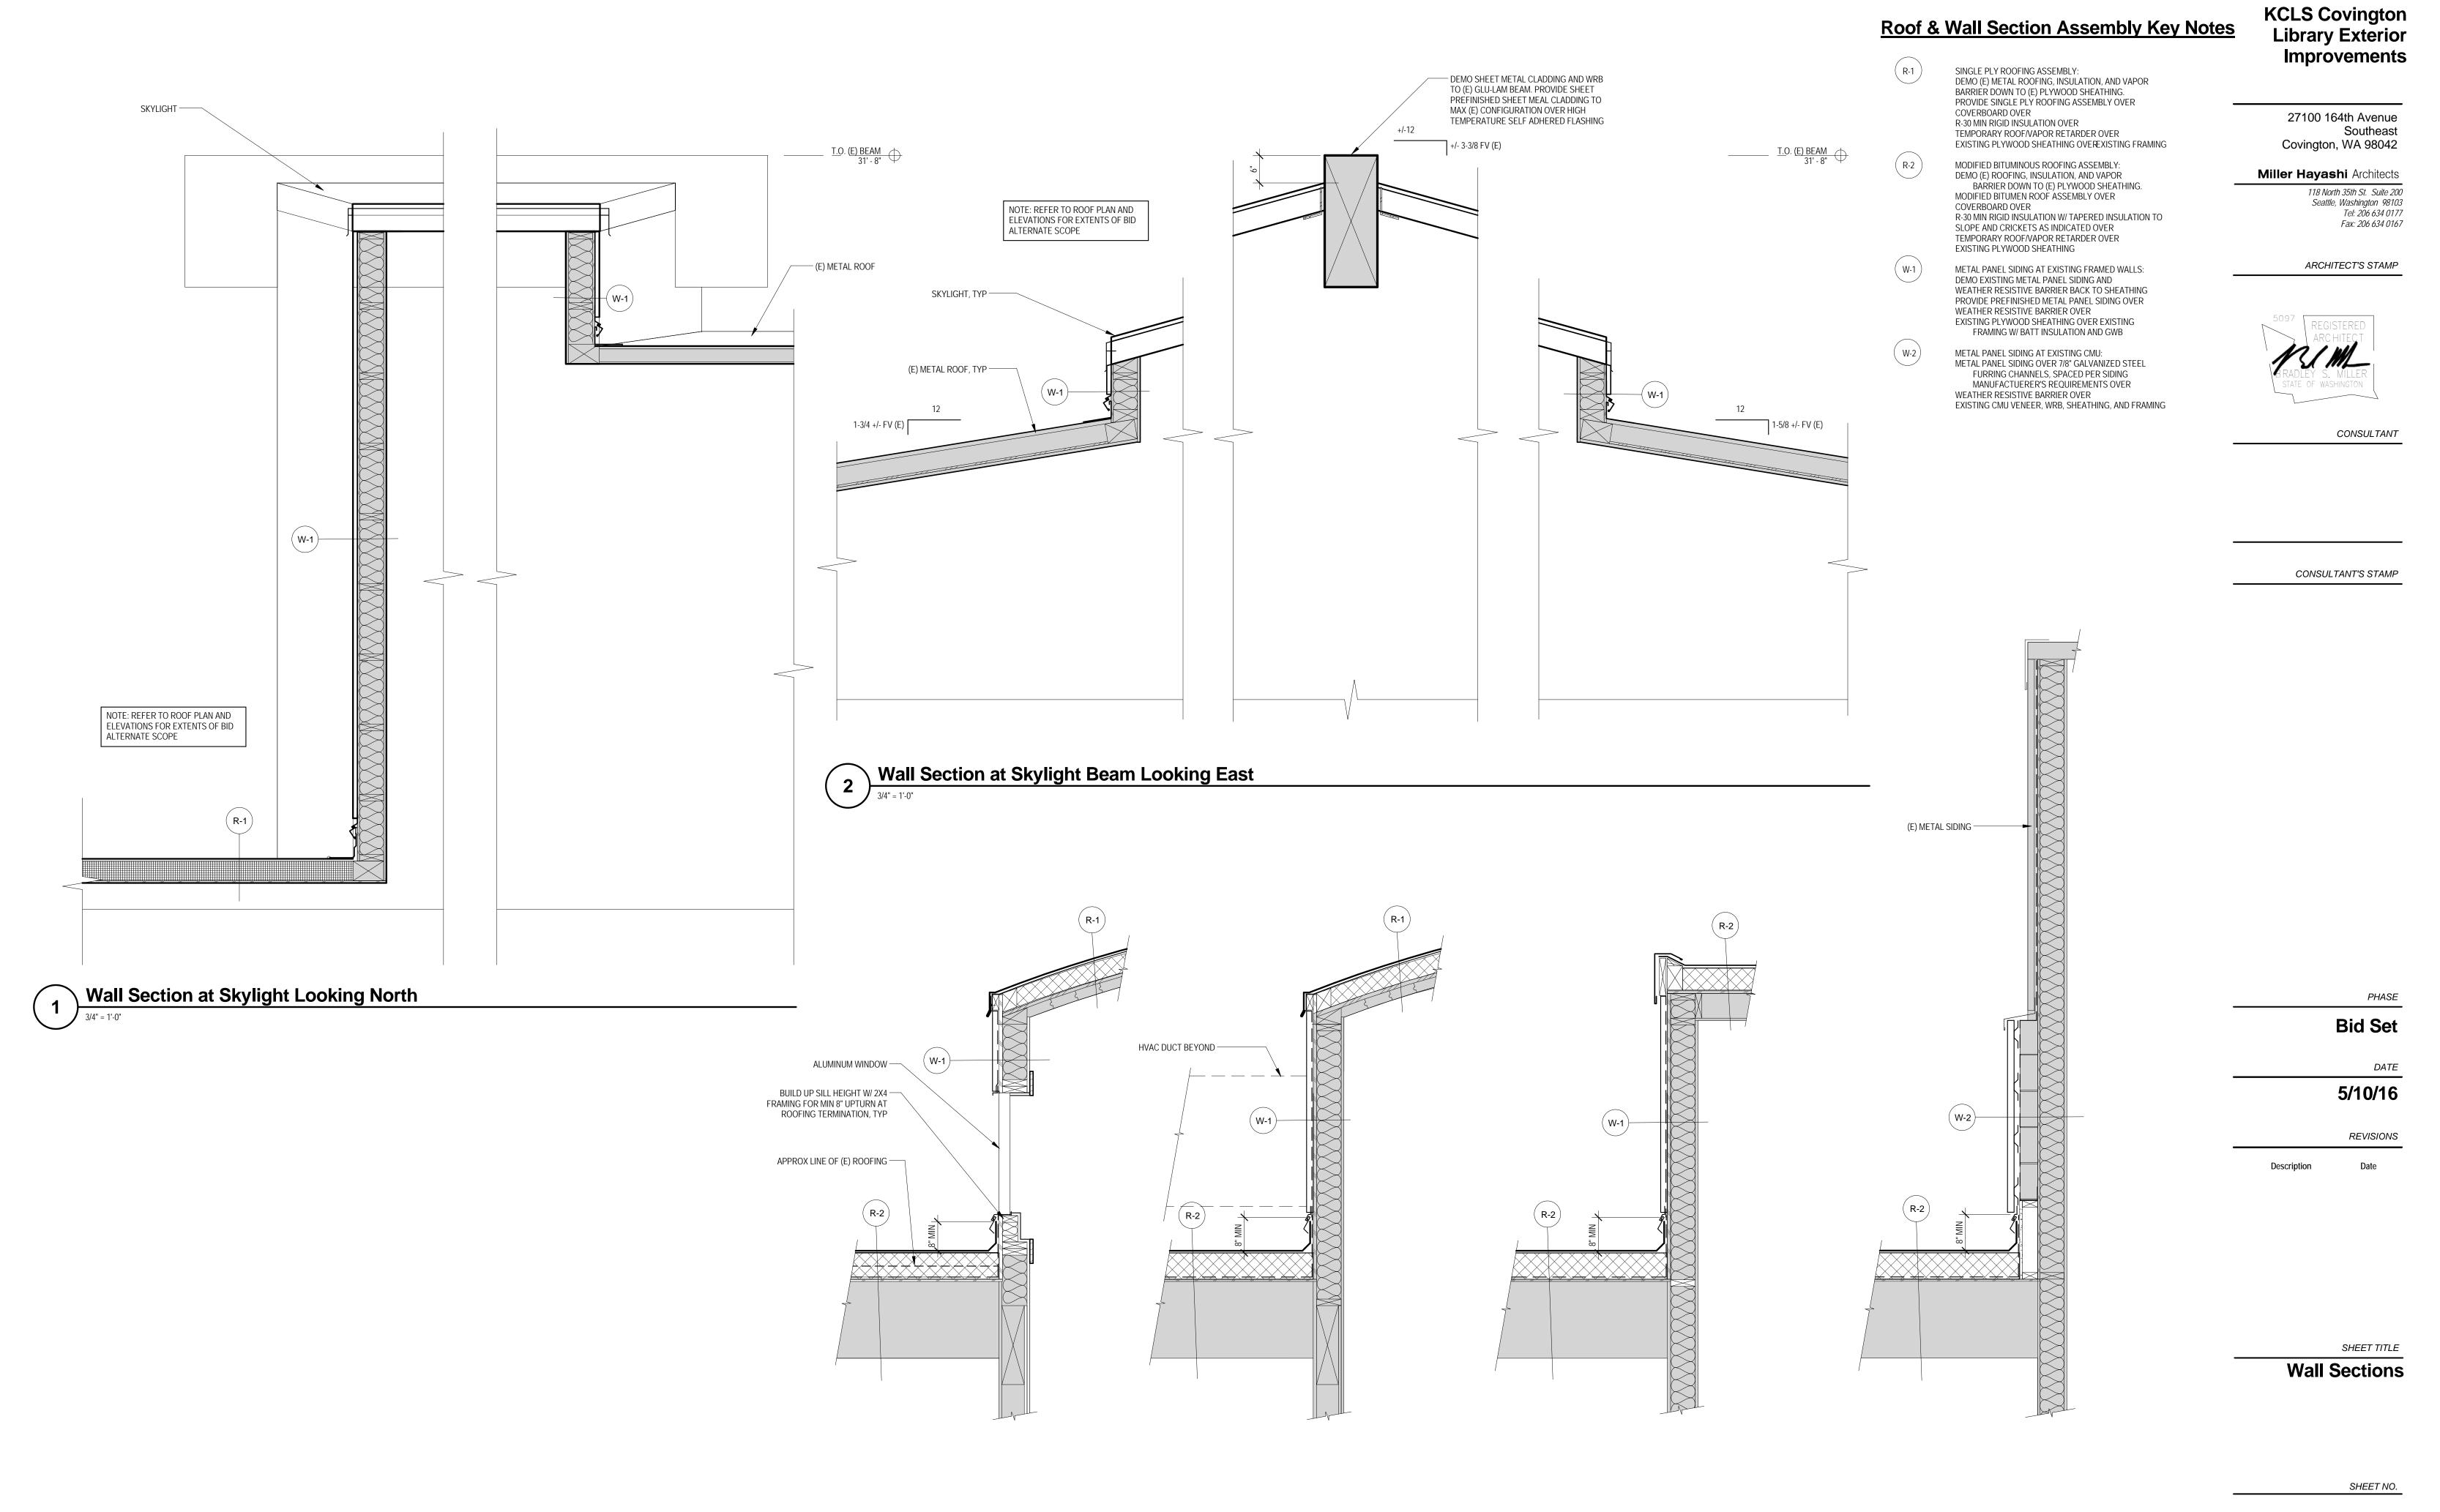METAL OVER CONTINUOUS REGLET,

Duct Penetration

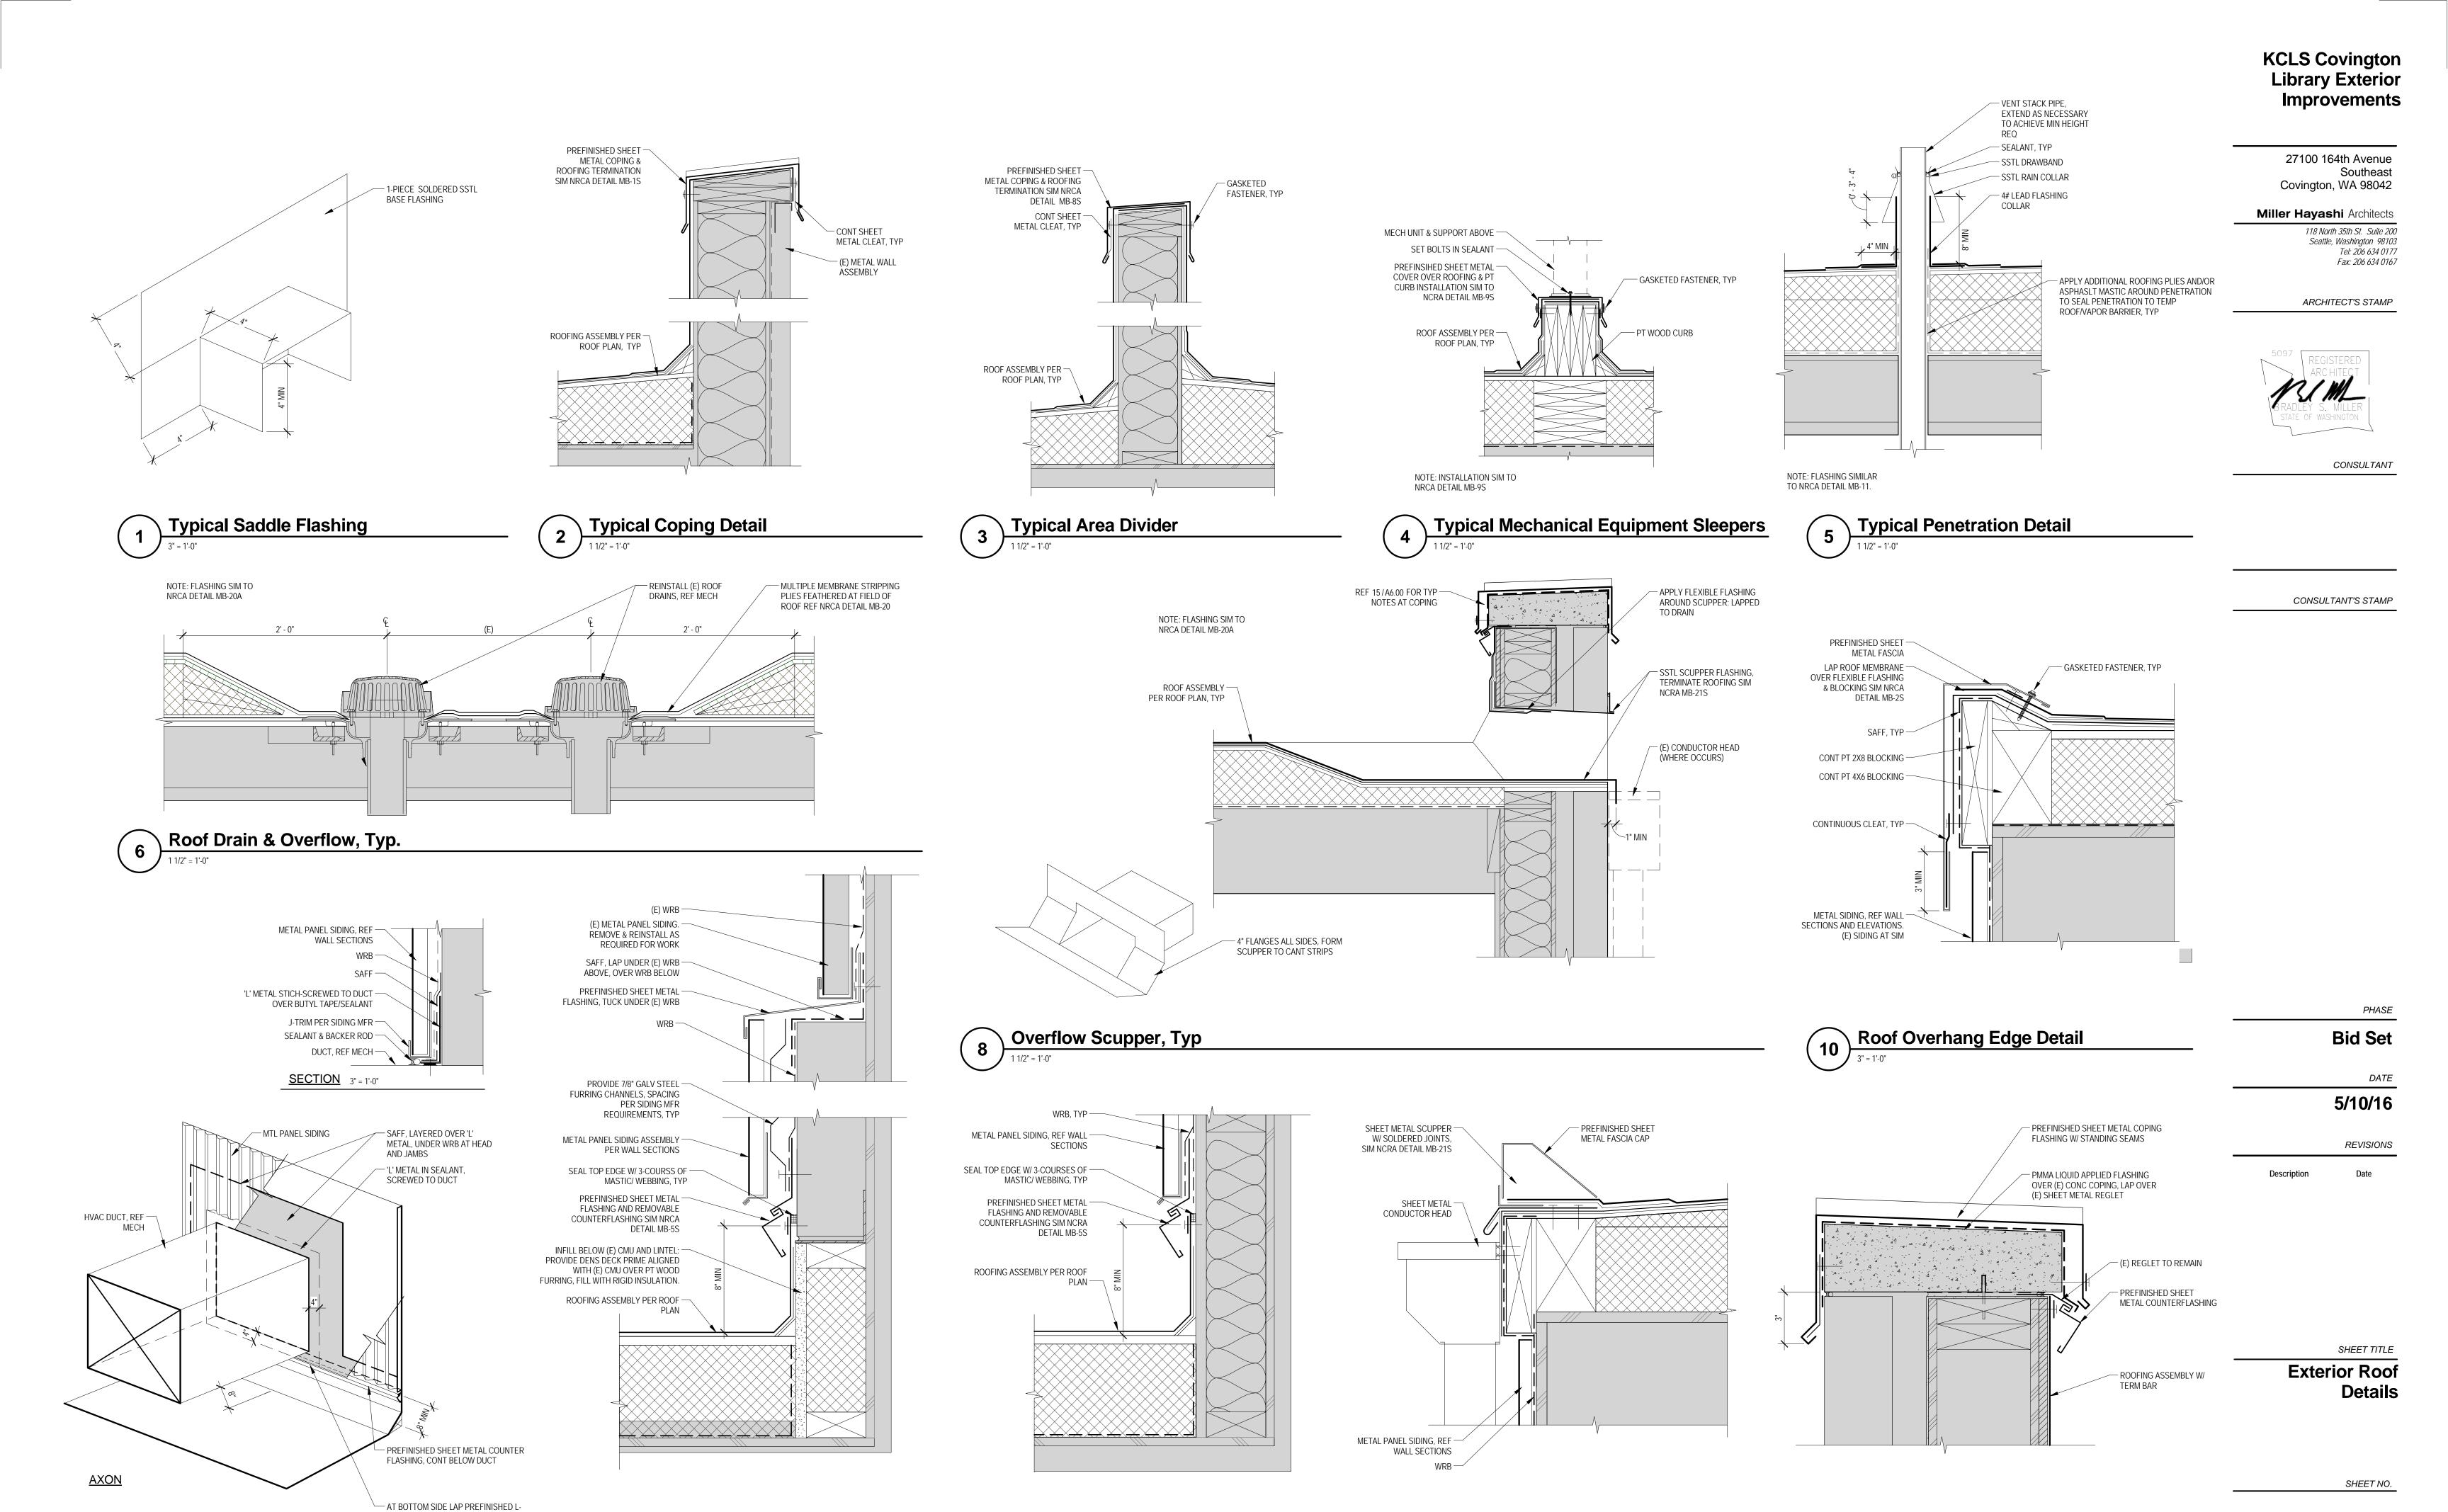1/2" - 1' ^"

A6.00


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Flashing at (E) Concrete Coping

3" = 1'-0"

Scupper through Raised Perimeter Edge

3" = 1'-0"

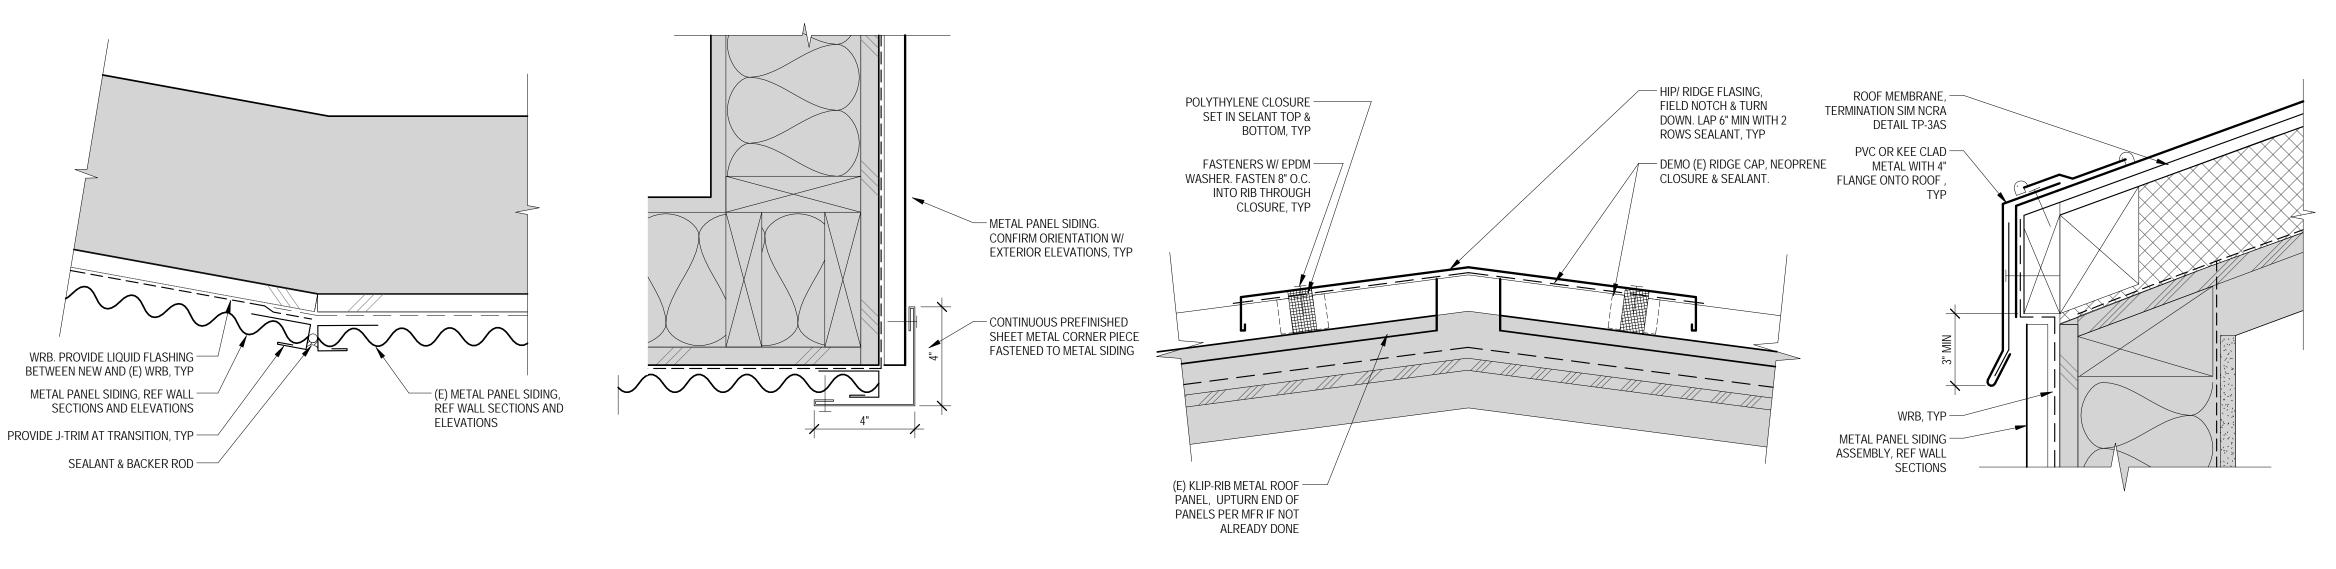

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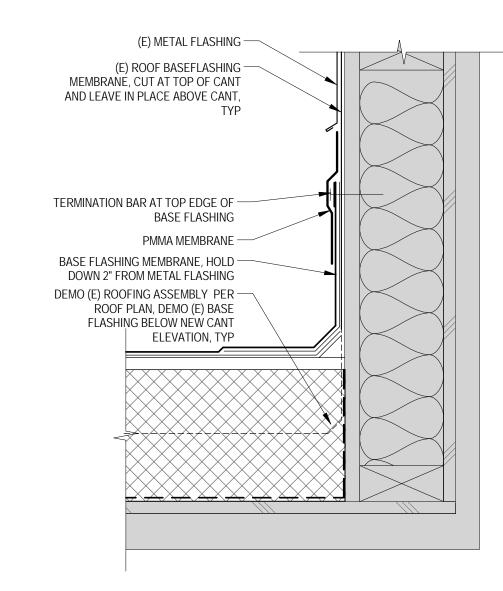



Metal Panel Siding at Corner


Ridge Cap Flashing at Metal Roof


Draining Perimeter Edge at Slope -Single Ply

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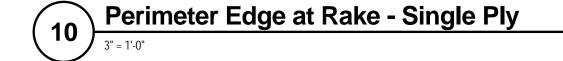




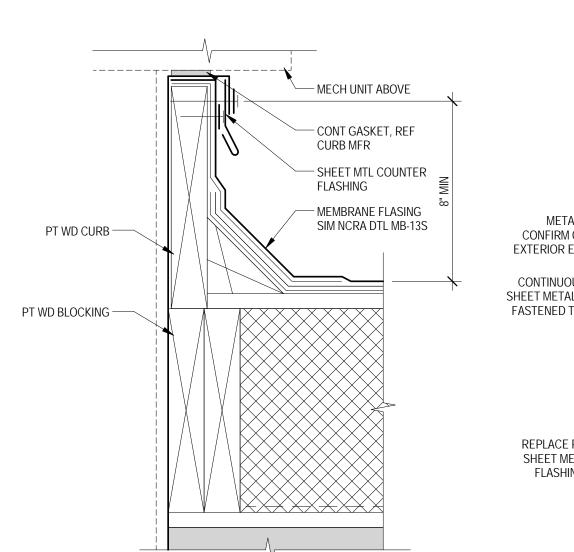

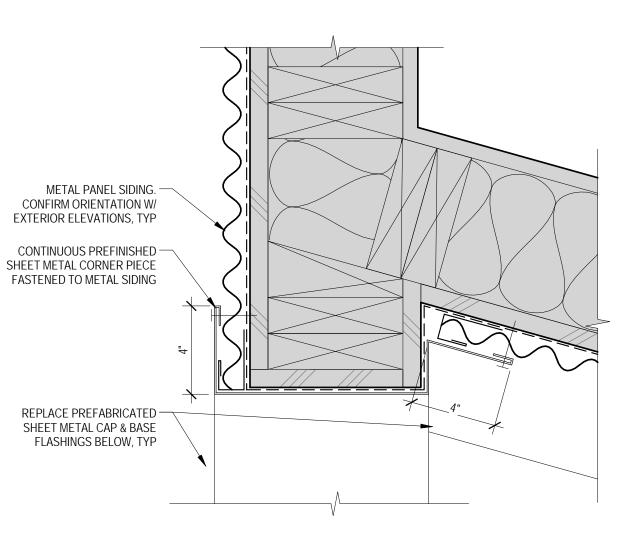

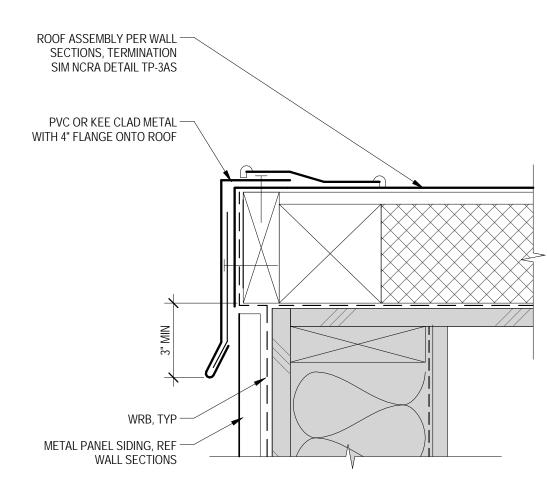



METAL PANEL SIDING, REF WALL

INSTALL COMPATIBLE SEALANT -

PREFINISHED SHEET METAL -FLASHING AND REMOVABLE

COUNTERFLASHING SIM NCRA

ROOFING FLASHING MEMBRANE

ROOFING ASSEMBLY PER —

BEHIND MEMBRANE

DETAIL TP-5S

ROOF PLAN

Bid Set DATE 5/10/16

PHASE


REVISIONS Description

SHEET TITLE

Exterior Roof Details

(E) METAL FLASHING TO REMAIN -(E) ROOF BASE FLASHING MEMBRANE TO REMAIN PMMA MEMBRANE OVER (E) -ROOFING AND BASE FLASHING MEMBRANE TO REMAIN, TYP

- METAL PANEL SIDING, REF WALL SECTIONS, TYP - LIQUID FLASHING, TYP — SEALANT & BACKER ROD, TYP — WALL PENETRATION

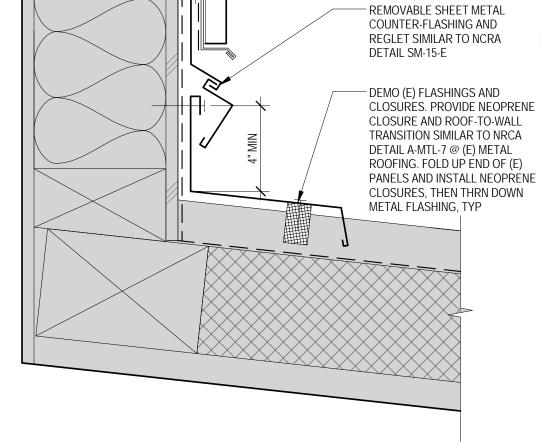

METAL PANEL SIDING, REF WALL SECTIONS

LAP BUILDING MEMBRANE

OVER REGLET FLASHING


Metal Siding at (E) Metal Roof (14)

Typical Base Flashing at Single Ply Roofing

SHEET NO.

12) PMMA at (E) Roofing

Hose Bib Detail

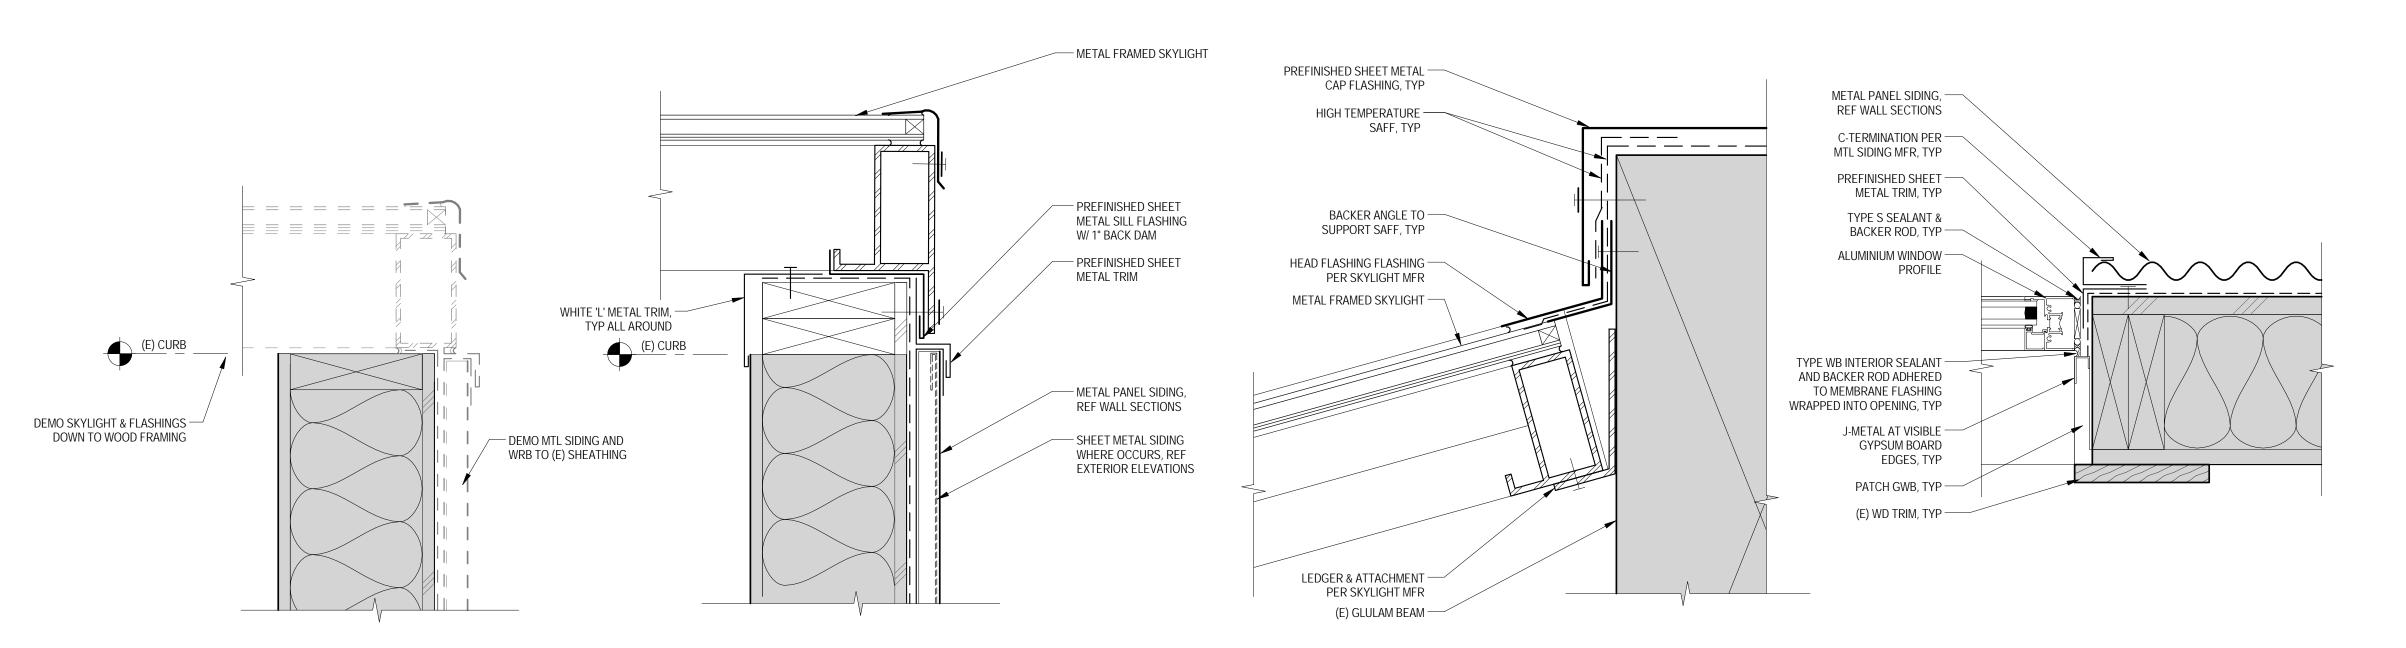



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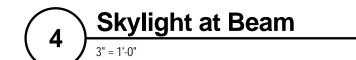
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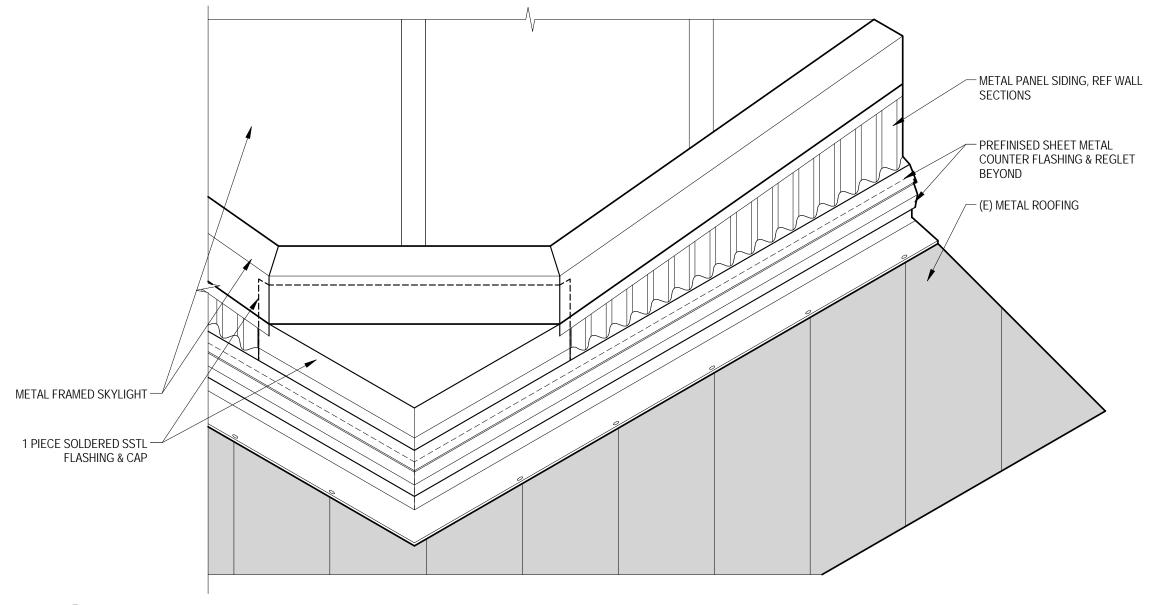








Window - Jamb Detail


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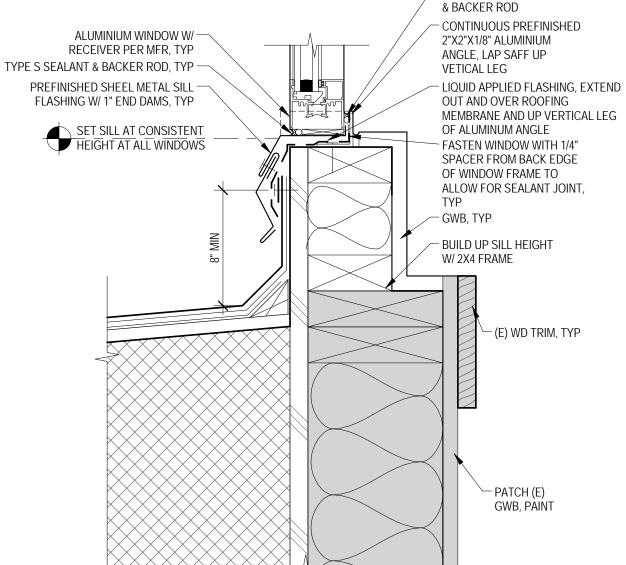




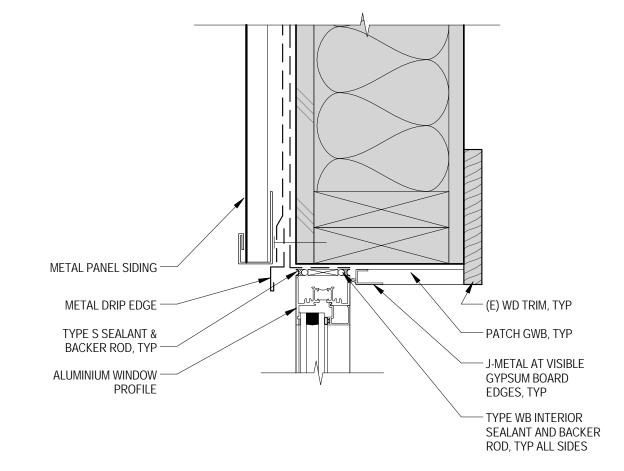

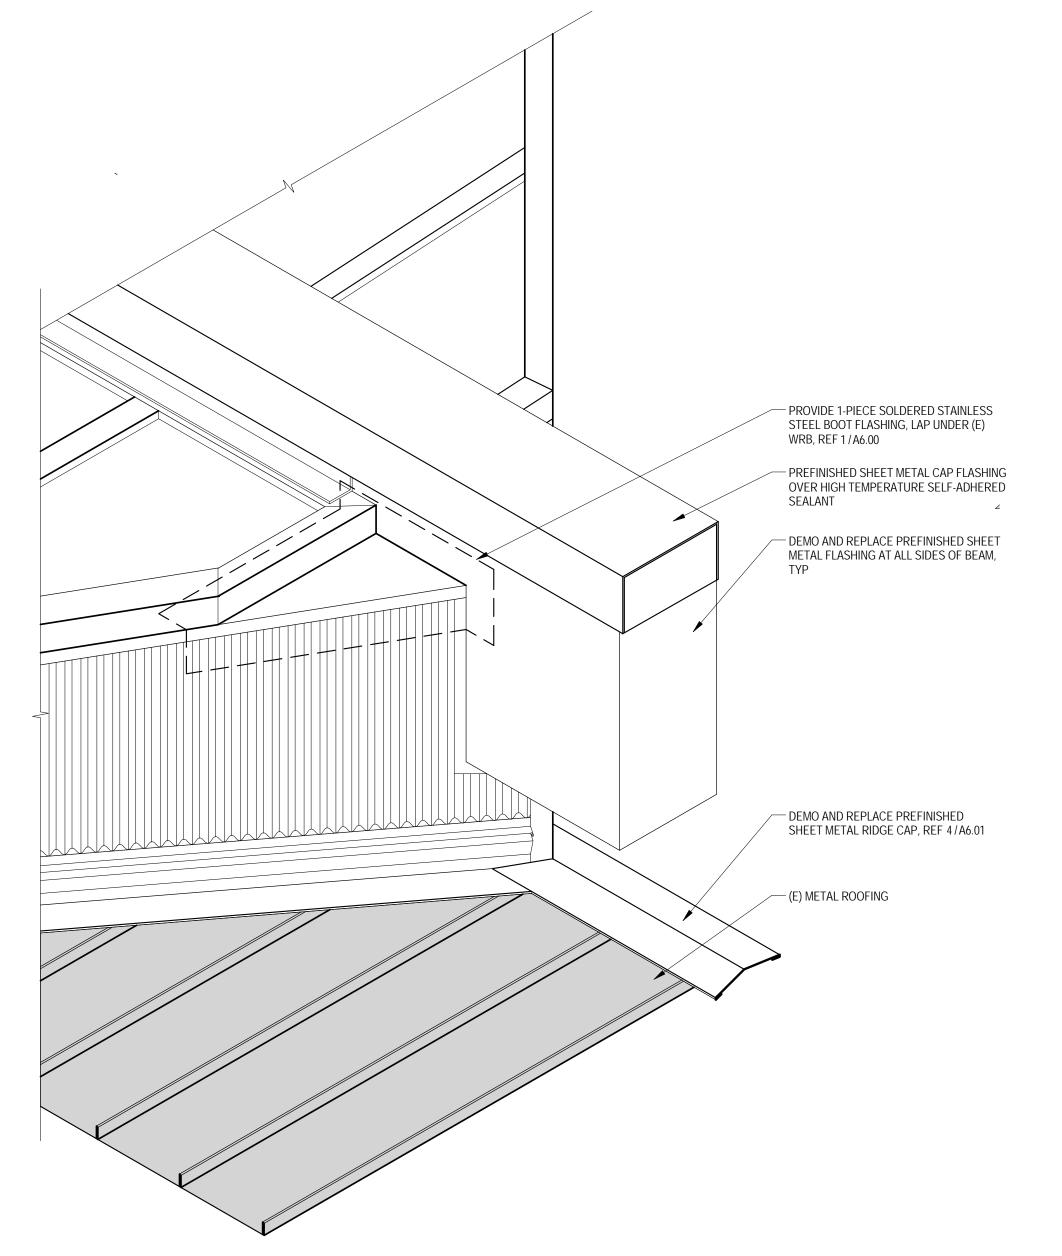Window - Head Detail

TYPE WB INTERIOR SELANT

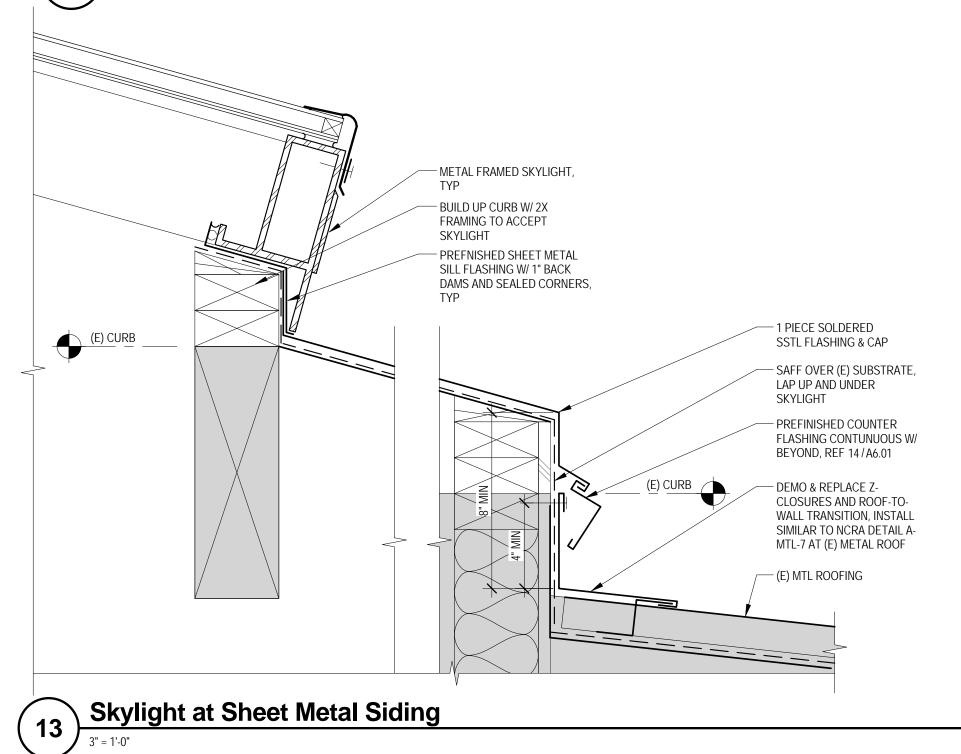

5/10/16 REVISIONS

Description


Bid Set

SHEET TITLE Window & **Skylight Details**

SHEET NO.

Window - Sill Detail

∑ Skylight Termination at Beam

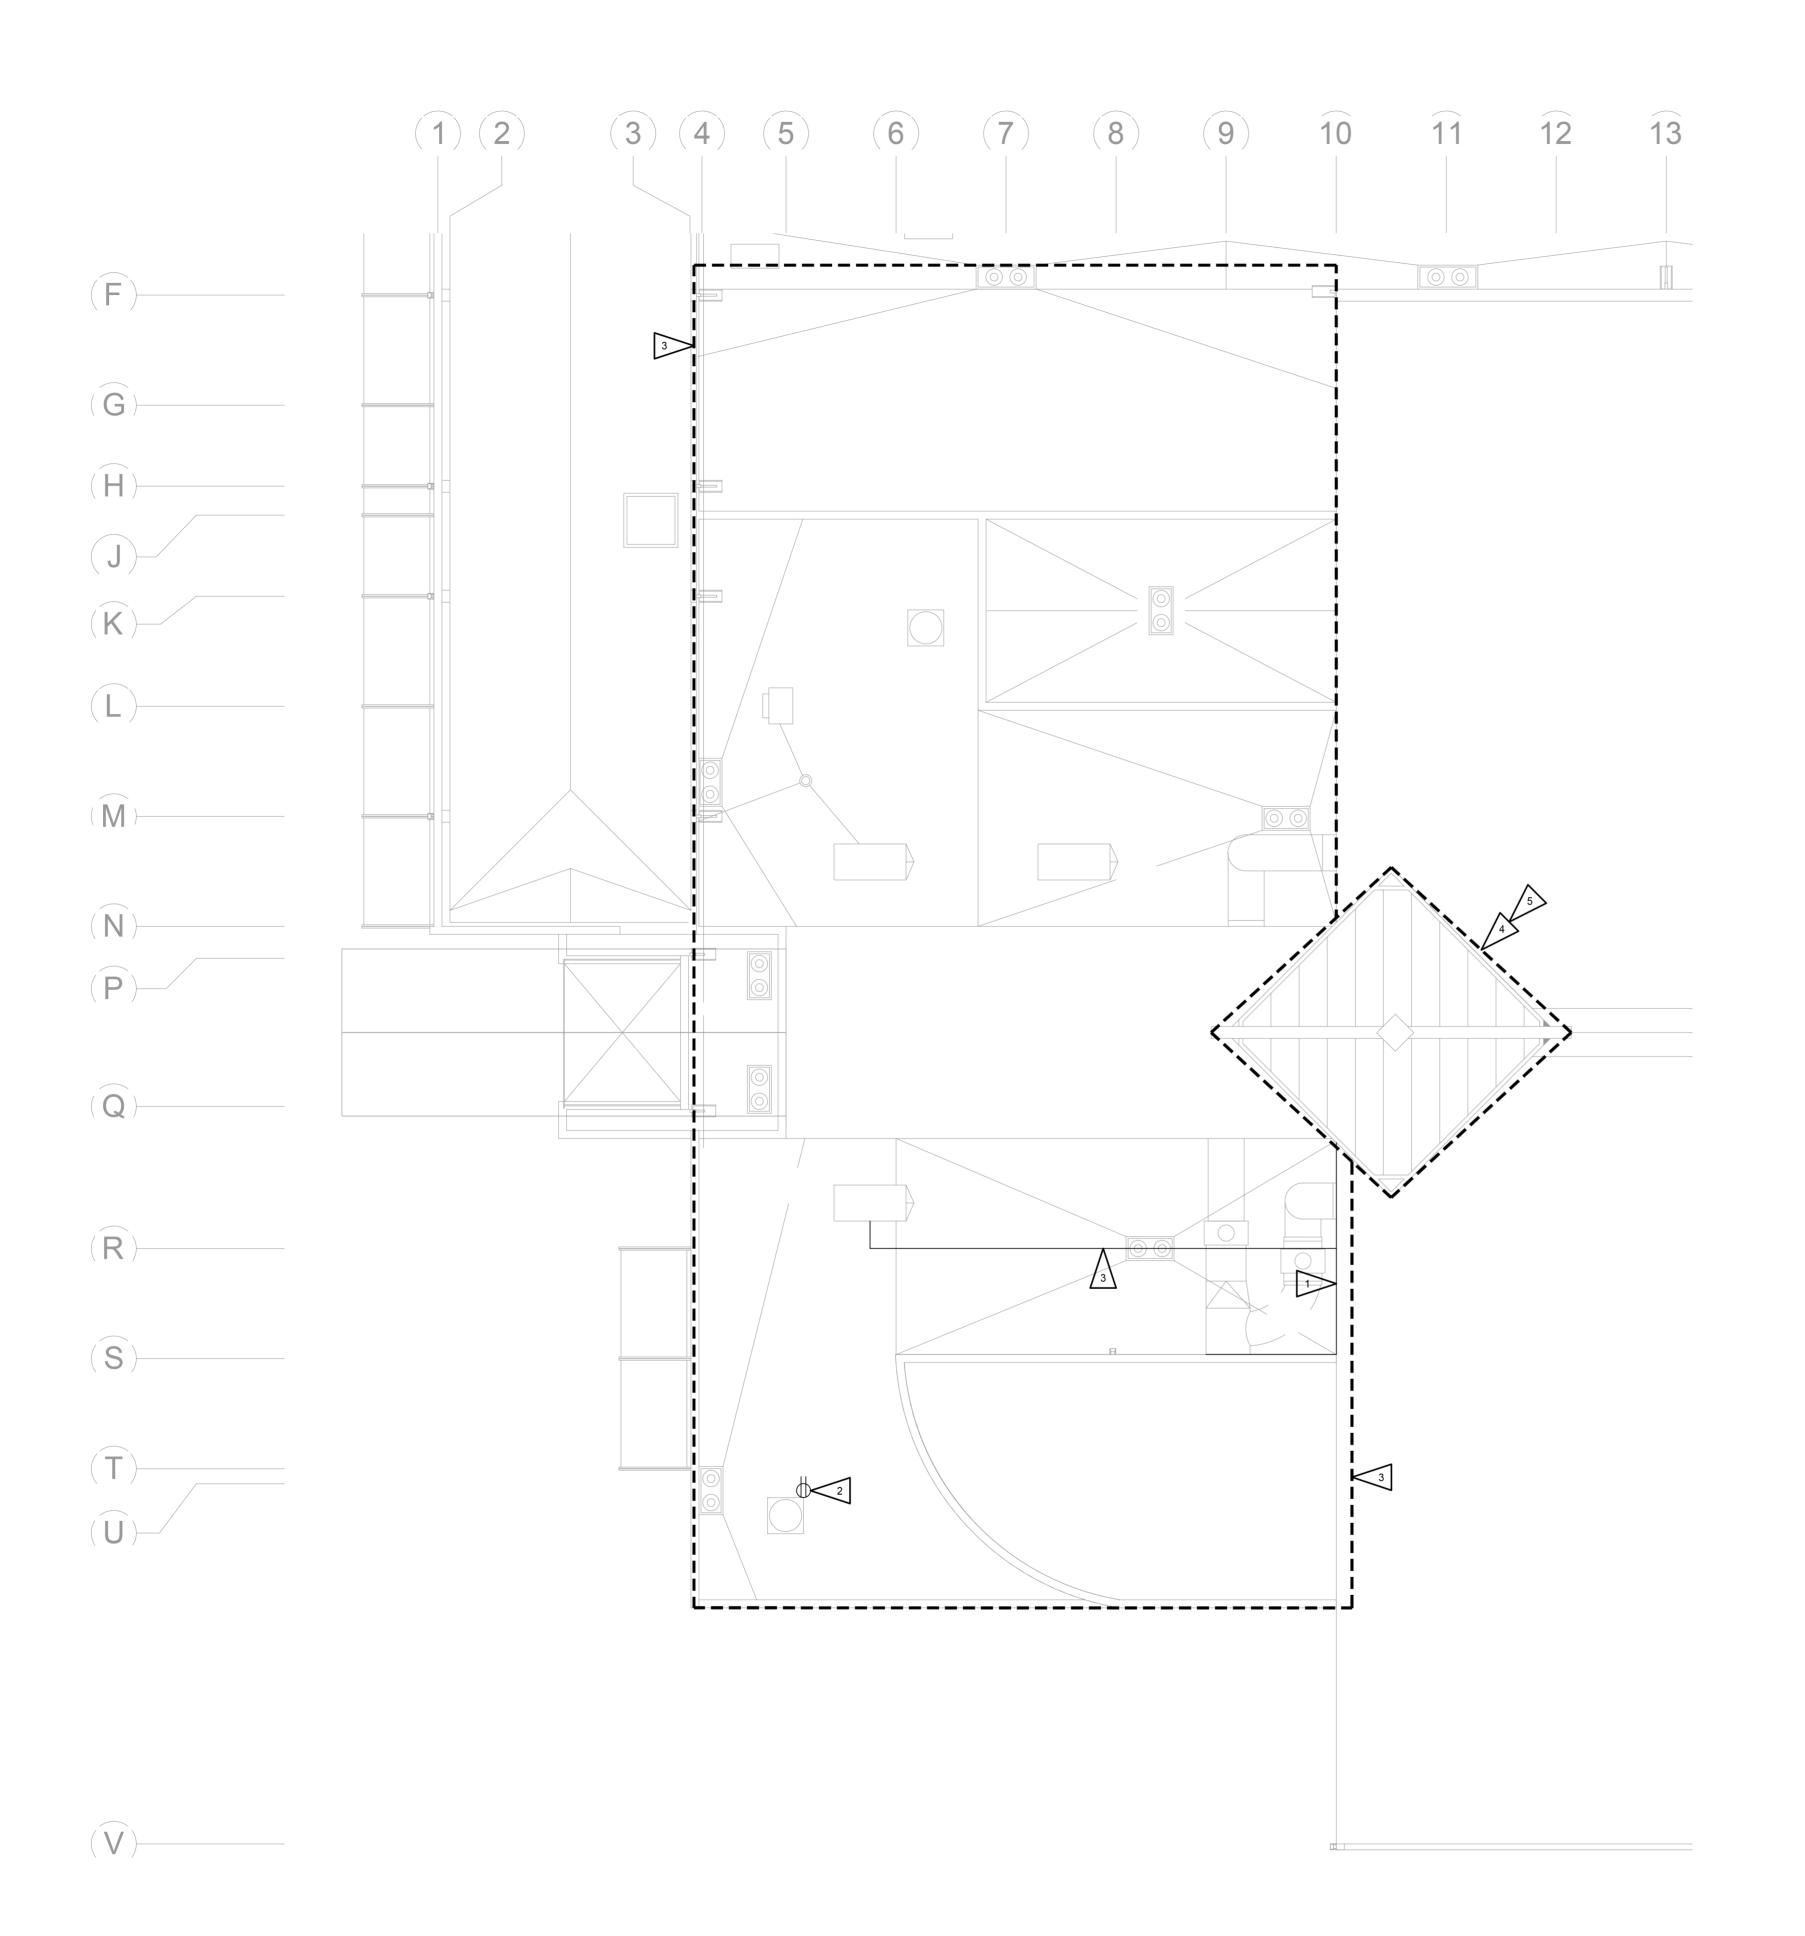



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ΗΛRGIS

mechanical electrical telecommunications seattle, washington 98101 seattle, washington 98101 t 206.448.3376 w hargis.blz

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FLAG NOTES:

COMPLETED.

SHEET NOTES:

1. FIELD VERIFY ALL EXISTING POWER AND LOW VOLTAGE

SYSTEMS THAT WILL REQUIRE RELOCATION DUE TO PARTIAL RE-ROOFING AND RE-CLADDING.

2. COORDINATE ANY POWER OR LOW VOLTAGE SYSTEM INTERRUPTIONS WITH OWNER. RE-TERMINATE ALL CONDUCTORS. PROVIDE AS-BUILD OF ALL POWER AND LOW VOLTAGE RELOCATIONS AND J-BOX LOCATIONS.

3. TEMPORARILY RELOCATE ALL ITEMS NOTED TO ALLOW ROOFING INSTALLATION. PERMANENTLY INSTALL ALL

NOTED ITEMS AFTER ROOFING INSTALLATION HAS BEEN

4. COORDINATE EXTENT OF EXPANDED WALL AND ROOFING

SURFACE THICKNESSES WITH ARCHITECTURAL.

RELOCATE EXISTING CONDUIT AND CONDUCTORS IN COORDINATION WITH MECHANICAL TO ALLOW FOR REINSTALLATION OF EXISTING MECHANICAL EQUIPMENT.

REMOVE EXISTING RECEPTACLE AND SAFE STORE FOR REINSTALLATION. REINSTALL AFTER COMPLETION OF ROOF DECK.

REMOVE SURFACE MOUNTED CONDUIT. REINSTALL AFTER COMPLETION OF ROOF DECK.

DEMO EXISTING STRIP LIGHTING AROUND SKYLIGHT.

5 SKYLIGHT WORK SCOPE IS INCLUDED UNDER BID ALTERNATE.

PHAS

Bid Set

5/10/16

REVISIONS


ription Date

SHEET TITLE

ELECTRICAL ROOF PLAN

SHEET NO.

E1.0

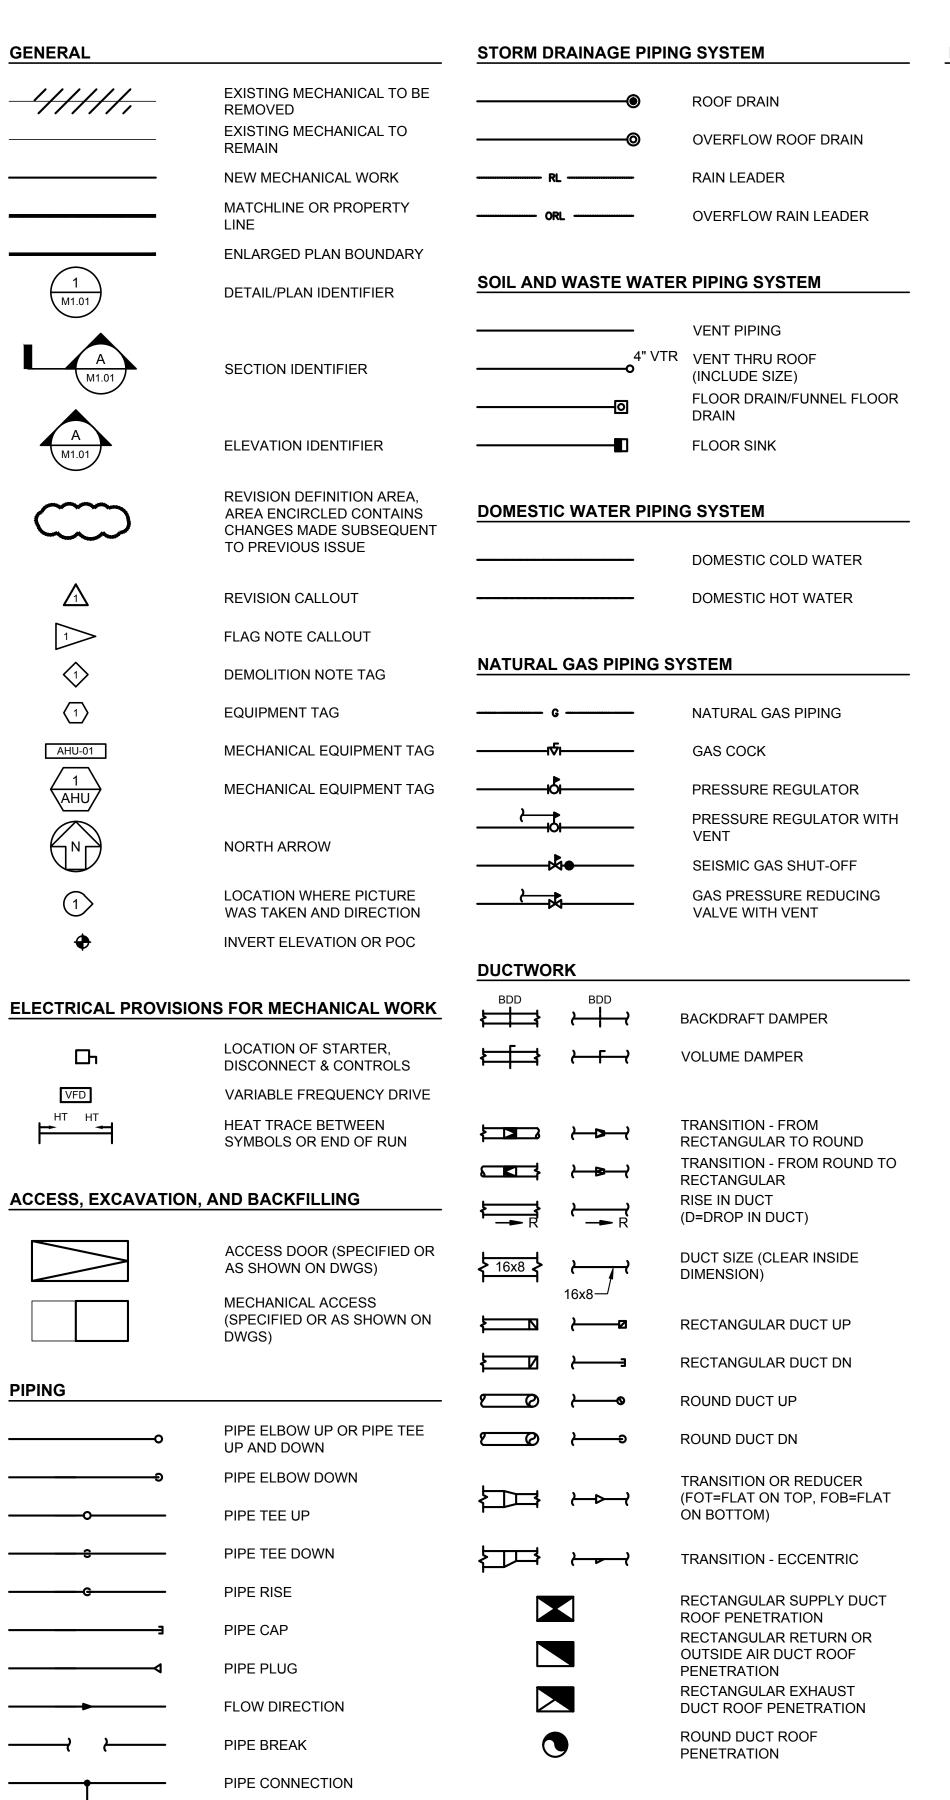

INLETS AND OUTLETS GRILLE REGISTER OR DIFFUSER TYPE - RUNOUT SIZE (INCHES) AIR QUANTITY (CFM) \boxtimes CEILING DIFFUSER 1-WAY DIRECTION FLOW $\leftarrow \boxtimes \rightarrow$ 2-WAY DIRECTION FLOW - \boxtimes \rightarrow 3-WAY DIRECTION FLOW RETURN/RELIEF AIR GRILLE EXHAUST AIR GRILLE LINEAR DIFFUSER/GRILLE SUPPLY GRILLE RETURN/EXHAUST GRILLE TRANSFER GRILLE **√-**RETURN/EXHAUST AIRFLOW SUPPLY AIR FLOW

ABBREVIATIONS ABV ACU AD ADA AFF AFUE AG AHJ AHU AMB APD

DIAMETER, PHASE **NOT APPLICABLE** NA NC NORMALLY CLOSED, NOISE CRITERIA AIR, AMPS NIC NOT IN CONTRACT NO. ABOVE NUMBER NTS NOT TO SCALE AIR CONDITIONER AIR CONDITIONING UNIT ACCESS DOOR OUTDOOR AIR AMERICANS WITH DISABILITIES ACT OBD OPPOSED BLADE DAMPER ORD ABOVE FINISHED FLOOR **OVERFLOW ROOF DRAIN** ORL AIRFLOW MEASURING STATION **OVERFLOW RAIN LEADER** OSA OUTDOOR SUPPLY AIR ANNUAL FUEL UTILIZATION EFFICIENCY ABOVE GROUND **AUTHORITY HAVING JURISDICTION** PH PHASE POC POINT OF CONNECTION AIR HANDLING UNIT AMBIENT PRESSURE REDUCING VALVE AIR PRESSURE DROP POUNDS PER SQUARE INCH GAGE ARCHITECT AMERICAN SOCIETY OF HEATING, REFRIGERATION QTY QUANTITY ASHRAE AND AIR-CONDITIONING ENGINEERS, INC. ATMOSPHERE RETURN AIR, RELIEF AIR RA RD ROOF DRAIN BACK DRAFT DAMPER REFERENCE, RETURN/EXHAUST FAN **RELIEF FAN**

RETURN GRILLE

ROOF HOOD

RAIN LEADER

ROOFTOP UNIT

SENSOR

SUPPLY AIR

SENSIBLE

INDICATOR

SIMILAR

TYPICAL

VALVE

VELOCITY

VOLTAGE

SA

SD

SIM

SOV

SPS

TYP

UG

VA

VEL

VFD

WB

VOLT

SCFM

REVOLUTIONS PER MINUTE

SUPPLY AIR TEMPERATURE

SUPPLY FAN, SQUARE FOOT

STATIC PRESSURE STATION

UNLESS NOTED OTHERWISE

STORM DRAIN PIPING

STEAM HEATING COIL

SHUTOFF VALVE

UNDERGROUND

VENT PIPING, VOLT

VOLUME DAMPER

VENT VENTILATION, VENTILATOR

VENT THRU ROOF

WALL CLEANOUT

WATER GAGE

WATER METER

WEIGHT

WSFU WATER SUPPLY FIXTURE UNIT

VARIABLE AIR VOLUME

VOLUME CONTROL DEVICE

VARIABLE FREQUENCY DRIVE

WASTE, WATT, WIDE, WATER

WET BULB (TEMPERATURE)

WATER CLOSET, WATER COLUMN

WATER HEATER, WALL HYDRANT

WATER HAMMER ARRESTOR

WSEC WASHINGTON STATE ENERGY CODE

UNIT HEATER

STANDARD CUBIC FEET PER MINUTE

SHEET METAL AND AIR CONDITIONING

STAINLESS STEEL, SANITARY SEWER

SUPPLY GRILLE, SIGHT GLASS WITH MOISTURE

CONTRACTORS' NATIONAL ASSOCIATION, INC.

ATM **BELOW FLOOR** BHP BRAKE HORSE POWER BLW BELOW BOD **BOTTOM OF DUCT** BOP BOTTOM OF PIPE BOT BTUH BALL VALVE

BRITISH THERMAL UNIT PER HOUR CONDENSATE PIPING CAP CAPACITY

CC COOLING COIL CEILING DIFFUSER, CONDENSATE DRAIN CFM CUBIC FEET PER MINUTE CG **CEILING GRILLE** CABINET HEATER, CHILLER CH CKV CHECK VALVE

CLG CEILING, COOLING CLEANOUT, CO SENSOR CO CO2 CO2 SENSOR COND CONDENSER, CONDENSATE CONN CONNECTOR

CONT CONTINUE, CONTROL COEFFICIENT OF PERFORMANCE CONDENSATE RECEIVER, CONDENSER WATER RETURN CS CONDENSER WATER SUPPLY

CONDENSING UNIT, CUBIC DRAIN DRY BULB (TEMPERATURE)

DECIBEL

EXISTING EXHAUST AIR ENTERING AIR TEMPERATURE ENERGY EFFICIENCY RATIO

EF **EXHAUST FAN** EFF **EFFICIENCY** EXHAUST GRILLE, ENGINE GENERATOR ELEVATION **EXTERNAL STATIC PRESSURE** EXH EXHAUST

FAHRENHEIT, FIRE MAIN PIPING FEET PER MINUTE FPS FEET PER SECOND FLOOR SINK FEET, FIN TUBE

FACE VELOCITY

GAGE GΑ GALV GALVANIZED GAS AIR HANDLING UNIT GAS COCK, GENERAL CONTRACTOR GAS PRESSURE REGULATING VALVE

GRILLES, REGISTERS, AND DIFFUSERS GATE VALVE, GLOBE VALVE

HUMIDISTAT, HEIGHT HOSE BIBB HC **HEATING COIL** HEAD, HUB DRAIN

HORIZONTAL HORSEPOWER, HEAT PUMP HTG HEATING

HVAC HEATING, VENTILATING, AND AIR CONDITIONING ΗZ HERTZ

kW KILOWATT

LENGTH LEAVING AIR TEMPERATURE LAT LBS POUND

THOUSAND BTU PER HOUR MECHANICAL CONTRACTOR

MINIMUM CIRCUIT AMPACITY MECH MECHANICAL MINIMUM EFFICIENCY REPORTING VALUE

MOCP MAXIMUM OVERCURRENT PROTECTION

MEDIUM PRESSURE GAS MPS MEDIUM PRESSURE STEAM DRAWING INDEX

LEGEND, ABBREVIATIONS, GENERAL NOTES AND SHEET

M1.01 MECHANICAL ROOF PLAN

M2.01 MECHANICAL DETAILS

GENERAL NOTES - MECHANICAL

1. COORDINATE MECHANICAL WORK WITH THAT OF OTHER TRADES (ELECTRICAL, ARCHITECTURAL, STRUCTURAL, CIVIL, AND LANDSCAPE). REFER TO ELECTRICAL, ARCHITECTURAL, STRUCTURAL, CIVIL, AND LANDSCAPE DRAWINGS AND SPECIFICATIONS. COORDINATION SHALL OCCUR PRIOR TO FABRICATION, PURCHASE, AND/OR INSTALLATION OF ALL WORK.

2. COORDINATE PLUMBING, HVAC, AND FIRE PROTECTION SYSTEMS ROUTING PRIOR TO INSTALLATION. DURING LAYOUT COORDINATION, DUCTWORK TAKES PRECEDENCE OVER PLUMBING, INCLUDING FIRE PROTECTION SYSTEMS.

3. THE CONTRACTOR SHALL BE RESPONSIBLE FOR THE SAFE KEEPING OF HIS OWN PROPERTY ON THE JOB SITE. OWNER ASSUMES NO RESPONSIBILITY FOR PROTECTION OF PROPERTIES AGAINST FIRE, THEFT, AND ENVIRONMENTAL CONDITIONS.

4. ACCESS CLEARANCES FOR MAINTENANCE AND REPLACEMENT: VERIFY PHYSICAL DIMENSIONS OF EQUIPMENT TO ENSURE THAT ACCESS CLEARANCES CAN BE MET. COORDINATE LOCATIONS OF MECHANICAL WORK AND WORK OF OTHER TRADES TO PROVIDE ACCESS CLEARANCES FOR SERVICE AND MAINTENANCE.

5. DISASSEMBLY PROVISIONS: PROVIDE UNIONS OR FLANGES AT PIPING CONNECTIONS TO EQUIPMENT, COILS, TRAPS, CONTROL VALVES, AND OTHER COMPONENTS TO ALLOW DISASSEMBLY FOR MAINTENANCE.

KCLS Covington Library Exterior Improvements

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Miller Hayashi Architects


118 North 35th St. Suite 200 Seattle, Washington 98103 Tel: 206 634 0177 Fax: 206 634 0167

ARCHITECT'S STAMP

CONSULTANT

HARGIS

CONSULTANT'S STAMP

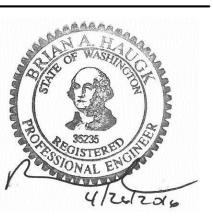

PHASE

Bid Set

DATE

5/10/16

REVISIONS

Date Description


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LEGEND. ABBREVIATIONS, **GENERAL NOTES AND SHEET INDEX**

NOT ALL SYMBOLS MAY

APPEAR ON THE DRAWINGS



MECHANICAL ROOF PLAN SCALE: 1/8" = 1'-0"

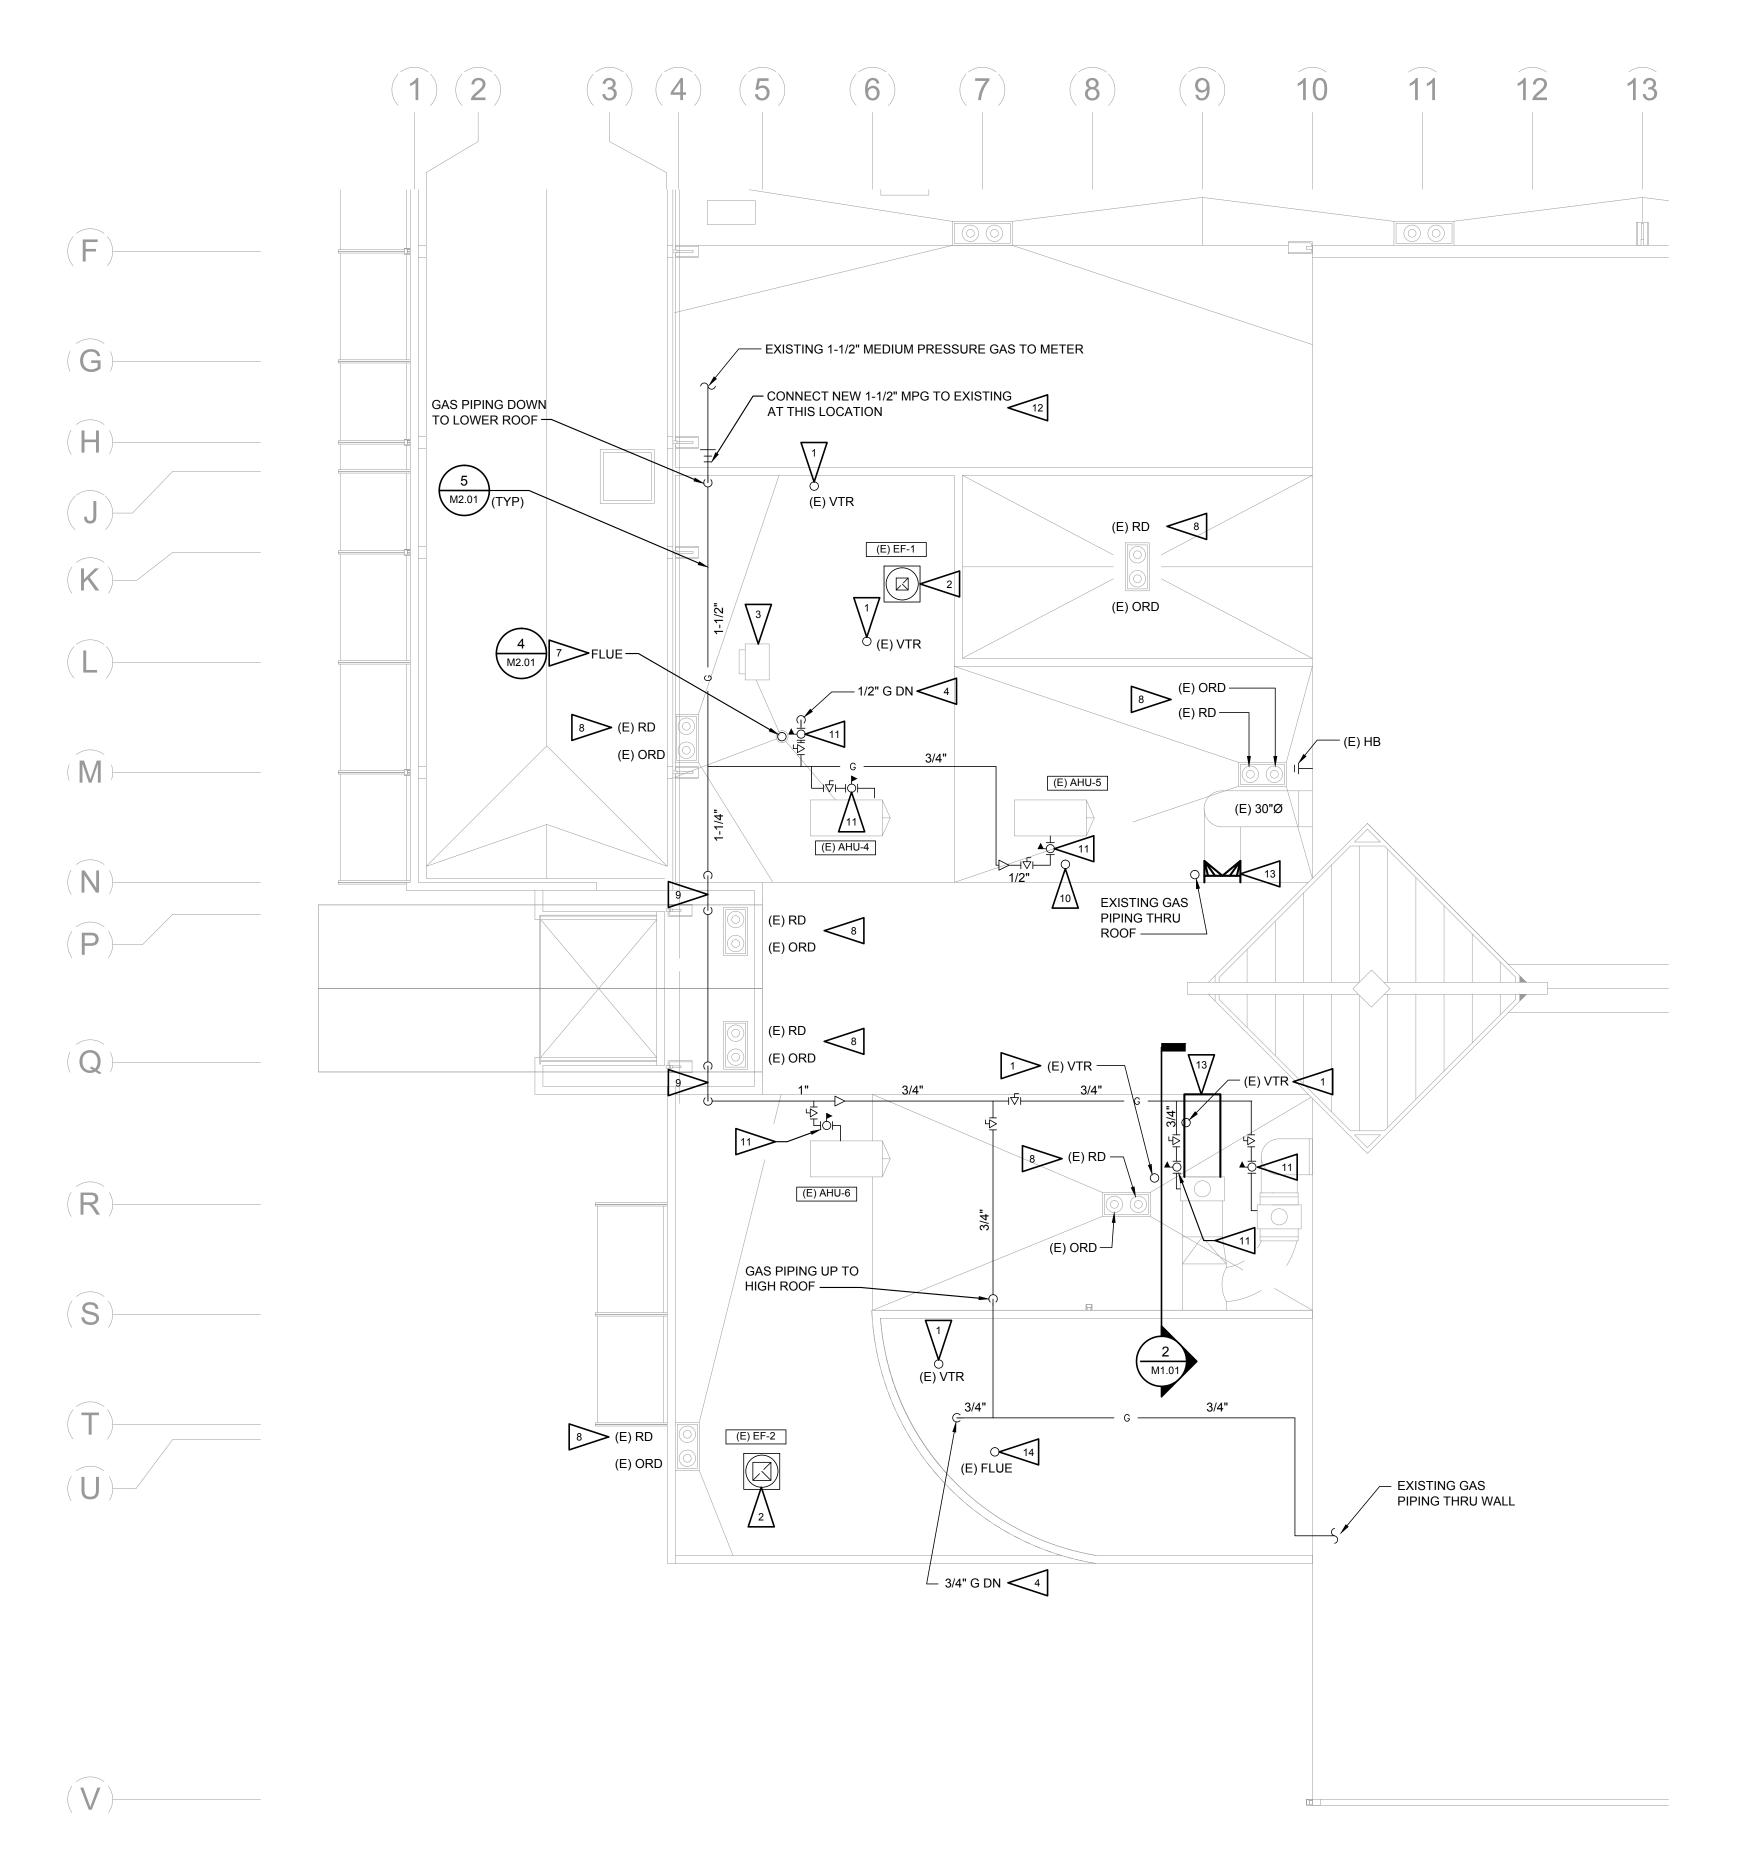FLAG NOTES:

- EXTEND EXISTING PLUMBING VENTS TO ACCOMMODATE INCREASED ROOF ASSEMBLY THICKNESS. TERMINATE A MINIMUM OF 12" ABOVE FINISHED ROOF LEVEL. PROVIDE VENT EXTENSIONS WITH NEW VANDAL PROOF VENT CAPS. PIPE COUPLING AT VENT EXTENSION SHALL BE COMPLETELY CONCEALED WITHIN ROOF INSULATION, BELOW FINISHED ROOF SURFACE. REFER TO ARCHITECTURAL DETAILS FOR FLASHING REQUIREMENTS.
- REMOVE EXISTING EXHAUST FAN AND SAFE STORE FOR REINSTALLATION. REINSTALL EXHAUST FANS SUCH THAT TOP OF CURB IS MINIMUM 8" ABOVE ROOF DECK. FIELD VERIFY EXISTING DUCT SIZE AND EXTEND AS REQUIRED TO RECONNECT TO FAN. NEW DUCTWORK SHALL BE INSTALLED IN ACCORDANCE WITH SMACNA STANDARDS.
- REMOVE EXISTING GOOSENECK INTAKE VENT AND SAFE STORE FOR REINSTALLATION. REINSTALL INTAKE VENT SUCH THAT TOP OF CURB IS MINIMUM 8" ABOVE ROOF DECK.
- EXISTING GAS PIPING THRU ROOF TO WATER HEATER BELOW. GAS SERVICE TO WATER HEATER SHALL NOT BE INTERRUPTED DURING NORMAL BUSINESS HOURS. ANY DOWNTIME REQUIRED FOR REPLACEMENT OF PIPING SHALL BE COORDINATED WITH THE LIBRARY MANAGER AND GENERAL CONTRACTOR.
- REMOVE EXISTING DUCT FURNACE AND SAFE STORE FOR REINSTALLATION. REINSTALL DUCT FURNACE ON EQUIPMENT SUPPORT PER ARCHITECTURAL. COORDINATE HEIGHT OF SUPPORT WITH ARCHITECT.
- REMOVE DUCTWORK AS REQUIRED TO FACILITATE REROOFING AND SAFE STORE FOR REINSTALLATION. INSPECT DUCTWORK FOR DAMAGE AND IMMEDIATELY NOTIFY ARCHITECT OF ANY ITEMS NOTED. REINSTALL EXISTING DUCTWORK EXCEPT AS NOTED ON THE PLANS. PROVIDE OFFSETS AND TRANSITIONS AS REQUIRED TO ACCOMMODATE INCREASED ROOF ASSEMBLY THICKNESS.
- REMOVE EXISTING FLUE THRU ROOF AND ASSOCIATED SUPPORT CABLES. INSTALL NEW TYPE B FLUE IN SAME LOCATION. FLUE CAP SHALL EXTEND 3'-0" ABOVE GOOSENECK INTAKE VENT. COORDINATE GUY WIRE TIE OFF LOCATIONS WITH GENERAL CONTRACTOR.
- 8 INSPECT ROOF DRAIN AND OVERFLOW ROOF DRAIN BODY, RECEIVER DECK AND SUMP FOR POSSIBLE CORROSION AND DETERIORATION. IMMEDIATELY NOTIFY ARCHITECT AND OWNER OF ANY ITEMS NOTED.
- 9 ROUTE GAS PIPING OVER PARAPET.
- REMOVE EXISTING GAS PIPE PENETRATION THRU ROOF. CAP BELOW ROOF DUCT.
- REMOVE EXISTING GAS REGULATOR AND SAFE STORE FOR REINSTALLATION. TAG EACH REGULATOR WITH UNIT SERVED TO ENSURE CORRECT CAPACITY IS MAINTAINED. REINSTALL REGULATOR PER DETAIL 6/M2.01.
- 12 REPLACE ALL GAS PIPING IN AREA TO BE REROOFED. GAS REGULATORS SHALL BE REUSED. NEW GAS COCKS SHALL BE PROVIDED AS SHOWN.
- NEW 27x27 LINED DUCT. CONNECT TO EXISTING 30"Ø DUCT TRAVERSING THE CLERESTORY. COORDINATE DUCT ATTACHMENT AT WALL AND BOTTOM HEIGHT OF DUCT WITH ARCHITECT PRIOR TO INSTALLATION. SEE SPECIFICATIONS FOR FURTHER DETAILS.
- REMOVE EXISTING CONCENTRIC FLUE FOR BOILER AND SAFE STORE FOR REINSTALLATION. REINSTALL FLUE SUCH THAT TOP IS A MINIMUM OF 12" ABOVE FINISHED ROOF LEVEL.

SHEET NOTES:

- MECHANICAL ITEMS SHOWN ON PLAN WERE TAKEN FROM
 (E) DRAWINGS AND WALK OF SITE. CONTRACTOR SHALL
 FIELD VERIFY QUANTITIES AND SIZES PRIOR TO BID AND
 REFERENCE ARCHITECTURAL DRAWINGS FOR COMPLETE
 SCOPE OF WORK AND INCLUDE WITHIN BID.
- CONTRACTOR SHALL VERIFY PROPER FUNCTION OF ALL EXISTING EQUIPMENT PRIOR TO BEGINNING ANY WORK. NOTIFY ARCHITECT AND OWNER OF ANY NON-WORKING EQUIPMENT.

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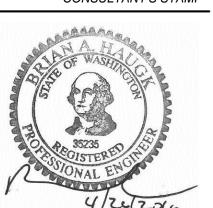
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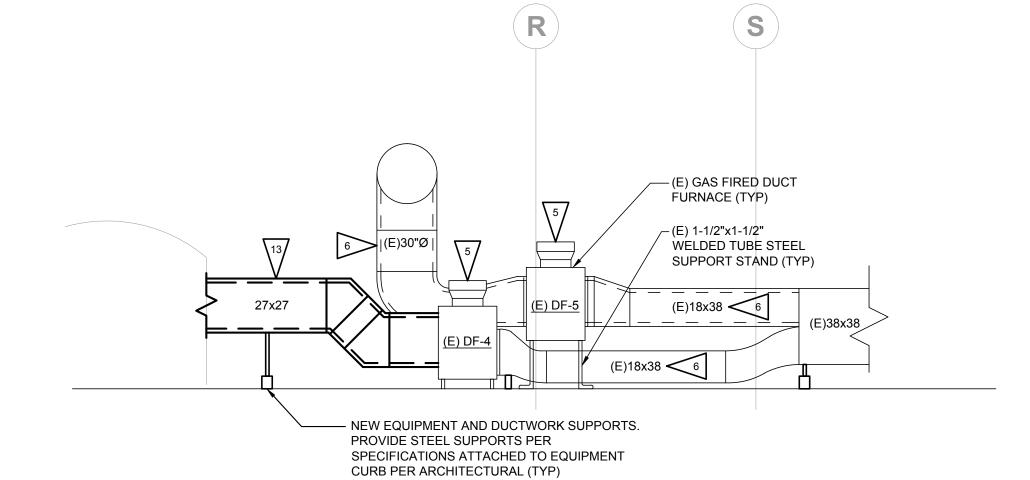
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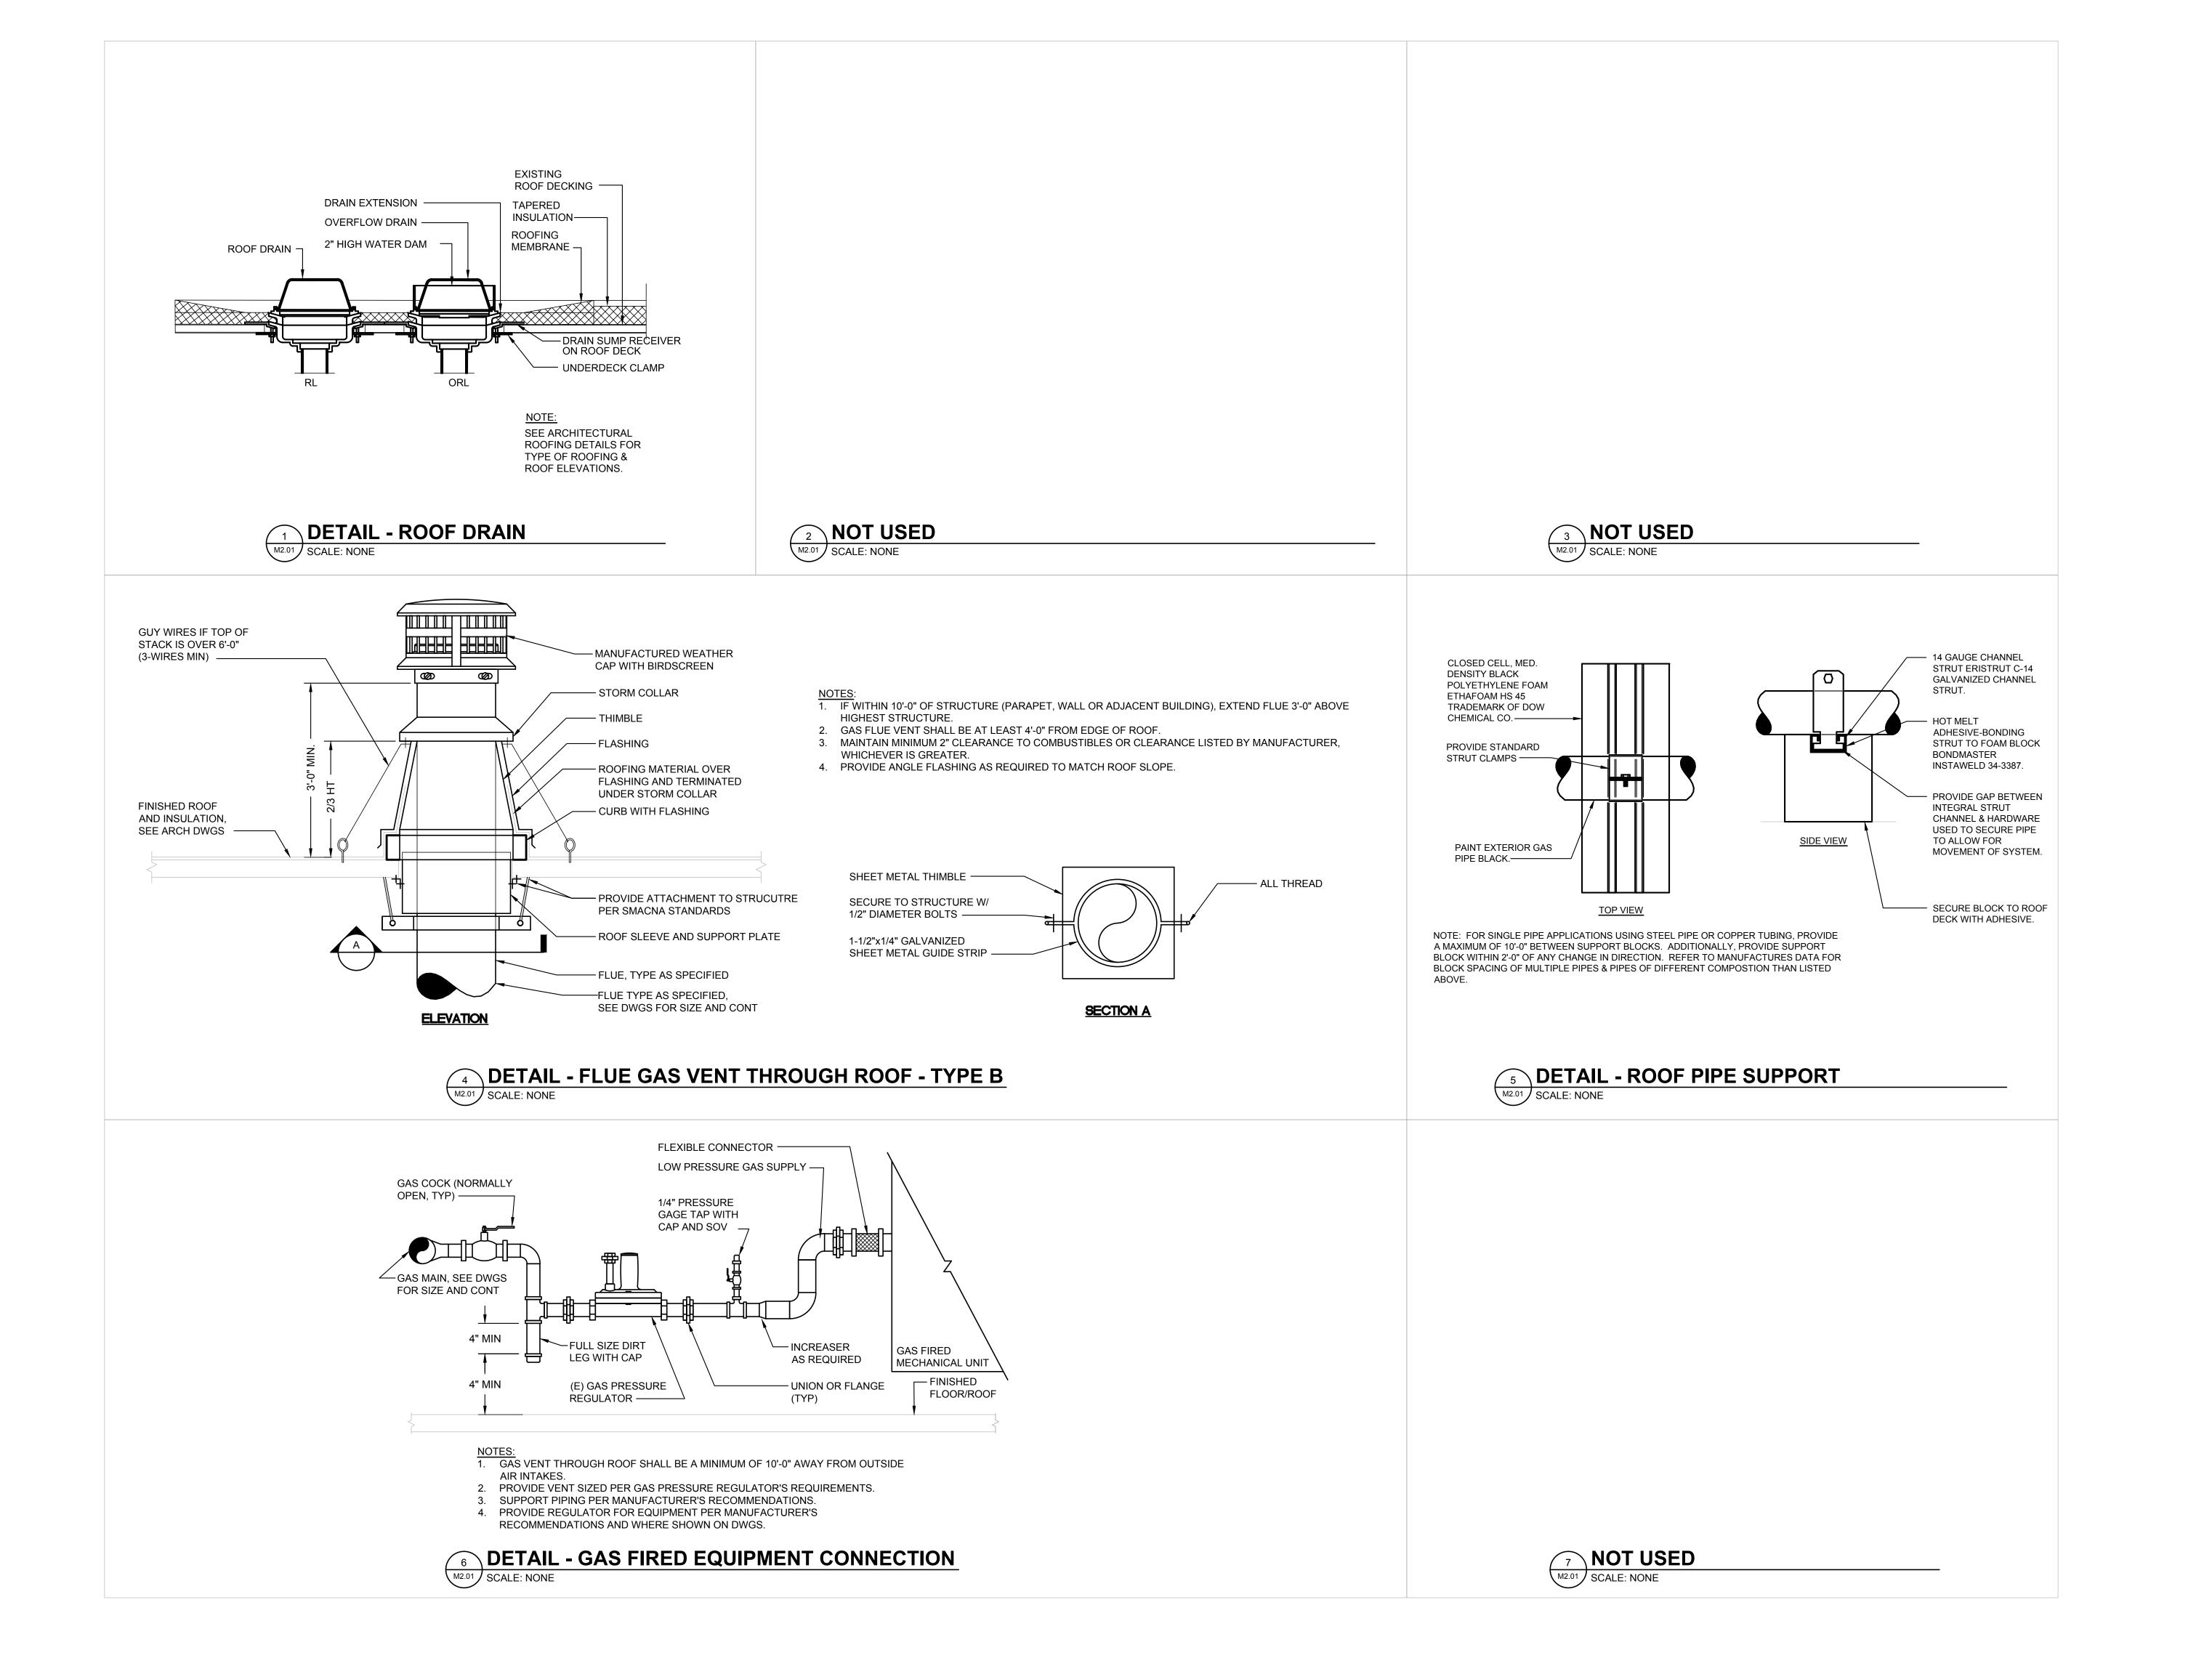
MECHANICAL ROOF PLAN

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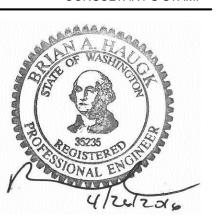
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